


LOXAHATCHEE RIVER ENVIRONMENTAL CONTROL DISTRICT WASTEWATER TREATMENT PLANT HEADWORKS STANDBY GENERATOR UPGRADES AND IMPROVEMENTS

GOVERNING BOARD

GORDON M. BOGGIE
JAMES D.SNYDER
DR. MATT ROSTOCK
STEPHEN B. ROCKOFF

CHAIRMAN
VICE CHAIRMAN
TREASURER
SECRETARY

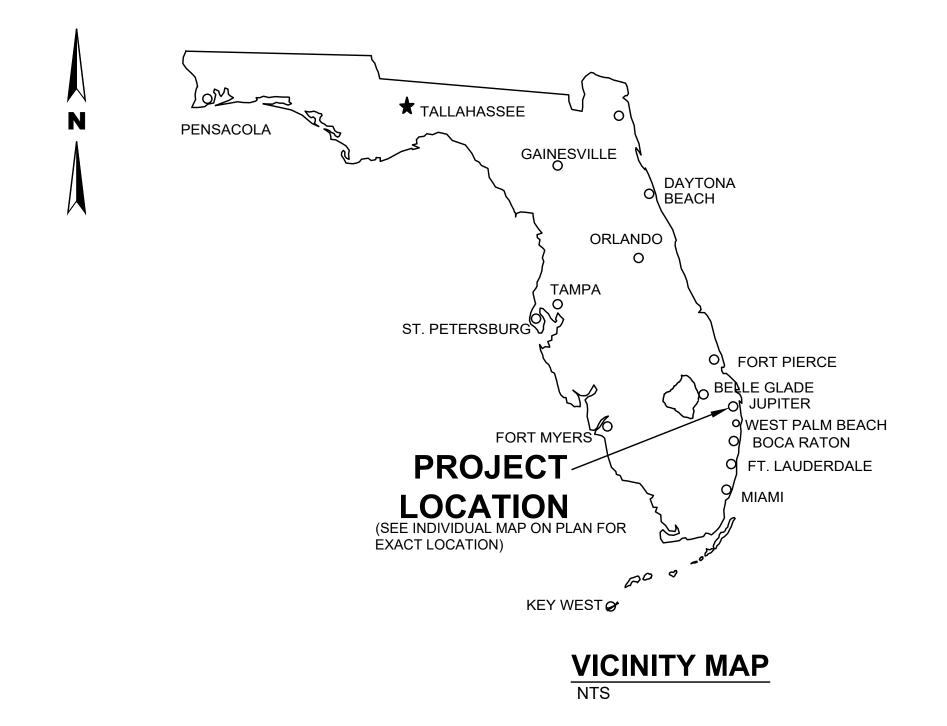

Larry M. Smith P.E.

No. 45997

IT'S THE LAW!

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UTILITIES NOTIFICATION CENTER

REPRODUCTION:
ATTENTION IS DIRECTED TO THE FACT THAT THESE
PLANS MAY HAVE BEEN REDUCED IN SIZE BY
REPRODUCTION. THIS MUST BE CONSIDERED WHEN
OBTAINING SCALED DATA.

For information regarding this project, contact:



2161 Palm Beach Lakes Blvd., Suite 312 West Palm Beach, Florida 33409 (561) 616-3911 fax (561) 616-3912 www.smithengineeringconsultants.com BID SET - DECEMBER 2020

DWG. No. TITLE

INDEX OF DRAWINGS

<u>T No</u>. <u>DWG. No</u>. <u>TITL</u>

) E-100 COVER SHE

E-101 ELECTRICAL PARTIAL FLOOR PLAN

E-102 MCC-8 SINGLE LINE DIAGRAM & LOAD CALCULATION

4 E 104 ELECTRICAL SPECS & DETAILS


GENERATOR NOTE:

THE CONTRACTOR SHALL INCLUDE IN HIS BID AND THE WORK THE PROCUREMENT OF THE LOCAL GENERAC SERVICE REPRESENTATIVE TO PERFORM THE FOLLOWING FUNCTIONS:

- 1. SUPERVISE THE RELOCATION AND INSTALLATION OF THE OWNER-FURNISHED GENERATOR BY THE CONTRACTOR.
- 2. PREPARE THE GENERATOR FOR STARTUP AND TESTING INCLUDING THE VERIFICATION OF ALL WIRING CONNECTIONS, PROPER FLUID LEVELS, ETC. AND SUBMIT A COMPLETED PRE-STARTUP CHECKLIST APPROVED BY THE MANUFACTURER.
- 3. PERFORM A STARTUP OF THE GENERATOR AND INCLUDING THE SIMULATION OF A LOSS OF POWER AND ALL FUNCTIONS OF THE AUTOMATIC TRANSFER SWITCH.
- 4. PERFORM A 2 HR. LOAD BANK TEST USING A RESISTIVE LOAD BANK AND PROVIDE TEST RESULTS.

SEC JOB NO. S20061

HEADWORKS BUILDING

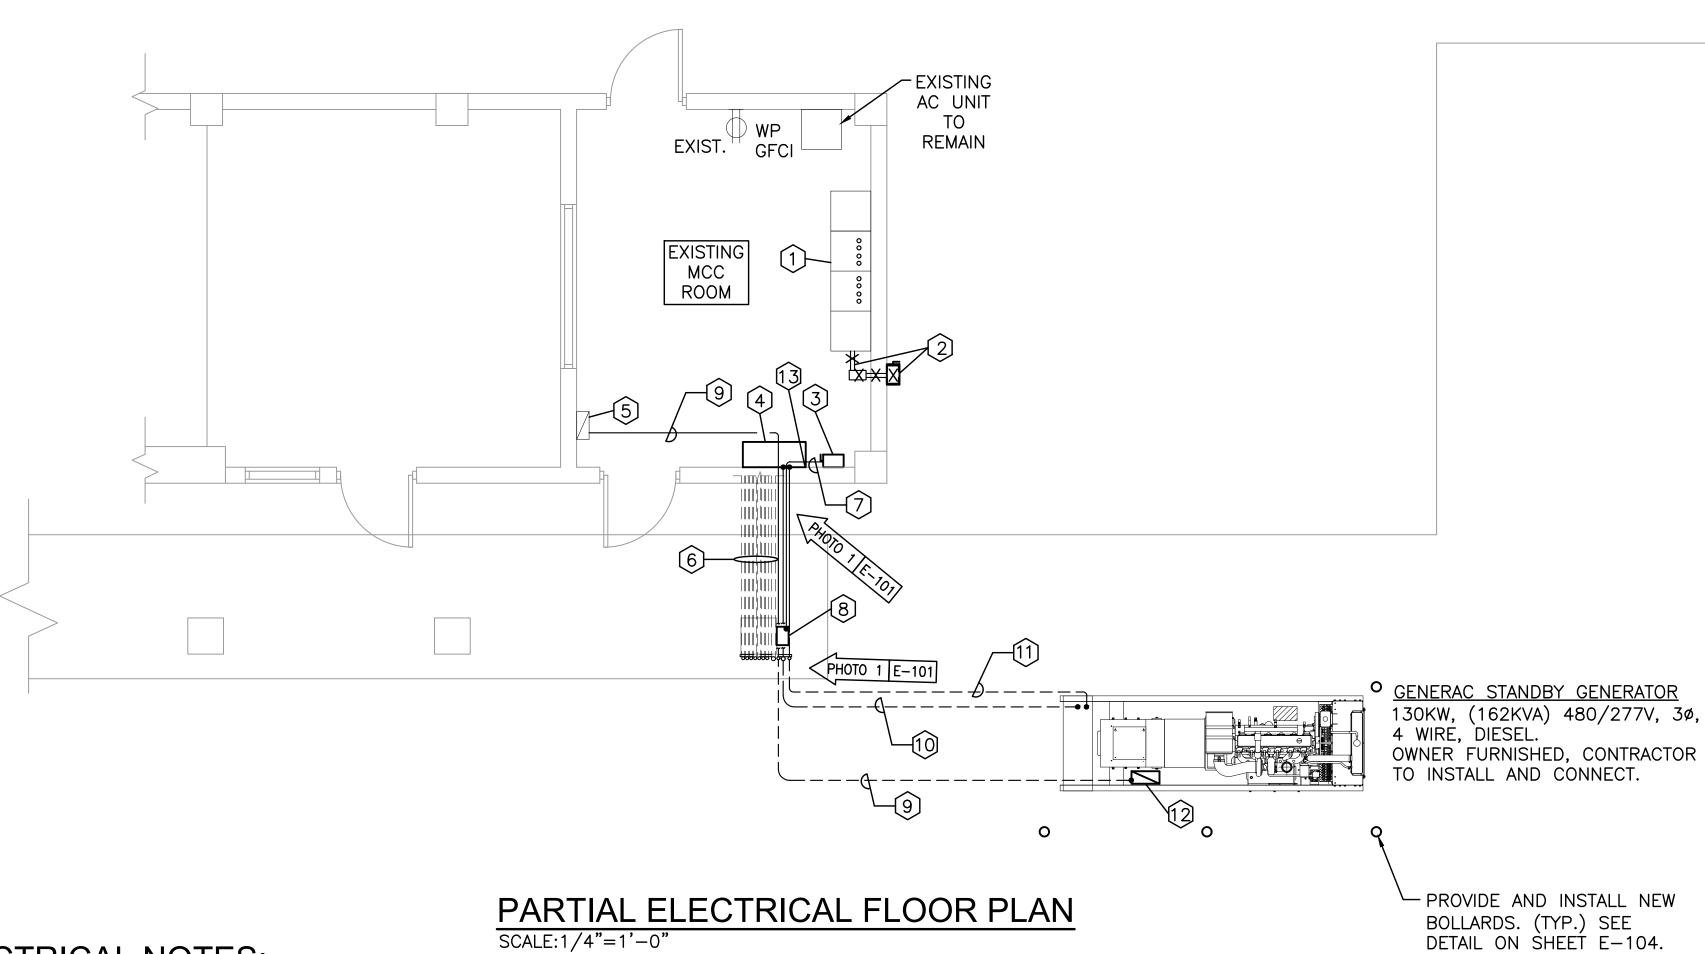


ELECTRICAL NOTES;


- (1) EXISTING MCC-8, 480/277, 3ø, 3W, 600AMPS.
- (2) EXISTING PORTABLE GENERATOR POWER DISCONNECT 3 POLE, 200AMPS, 480VAC TO BE REMOVED INCLUDING THE PORTABLE GENERATOR PLUG.
- (3) NEW EMERGENCY GENERATOR DOUBLE THROW SWITCH, 480/277VAC, 3 POLE, 400AMPS.
- 4 NEW EMERGENCY A.T.S., 480VAC, 3 POLE, 225AMPS, NEMA 1 ENCLOSURE. (DISTRICT PROVIDED)
- (5) EXISTING PANEL 'L', 120/240VAC, 1ø, 3W, 225AMPS, 150AMP MCB.
- 6 EXISTING CONDUITS NOT PART OF THIS PROJECT.
- 7 CONDUIT CONNECTING NEW DOUBLE THROW SWITCH AND NEW PORTABLE GENERATOR PLUG CIRCUIT. REFER TO ELECTRICAL RISER DIAGRAM ON SHEET E-103 FOR FEEDER AND CONDUIT SIZES.
- 8 NEW GENERATOR PLUG, 480VAC, 3ø, 3W, 200AMPS, NEMA 3R WEATHERPROOF ENCLOSURE. MOUNT TO EXISTING COLUMN AT ACCESSIBLE
- (9) CONDUIT CONNECTING NEW GENERATOR BATTERY CHARGER AND COOLENT HEATER CIRCUIT FROM EXISTING PANEL 'L'. REFER TO ELECTRICAL RISER DIAGRAM ON SHEET E-103 FOR FEEDER AND CONDUIT SIZES.
- $\widehat{\mathbb{O}}$ conduit connecting new a.t.s. and generator power circuit. Refer to electrical riser diagram on sheet $\mathrm{e}-103$ for feeder and CONDUIT SIZES.
- (1) CONDUIT CONNECTING NEW A.T.S. AND GENERATOR CONTROL CIRCUIT. REFER TO ELECTRICAL RISER DIAGRAM ON SHEET E-103 FOR FEEDER AND CONDUIT SIZES.
- (2) GENERATOR CONNECTION POINT FOR HEATER, BATTERY CHARGER. VERIFY IN FIELD IN ENCLOSURE.
- (3) CONTRACTOR SHALL REMOVE EXISTING WALL MOUNTED THERMOSTAT.



LOXAHATCHEE RIVER WASTEWATER TREATMENT PLANT LOCATION KEY PLAN

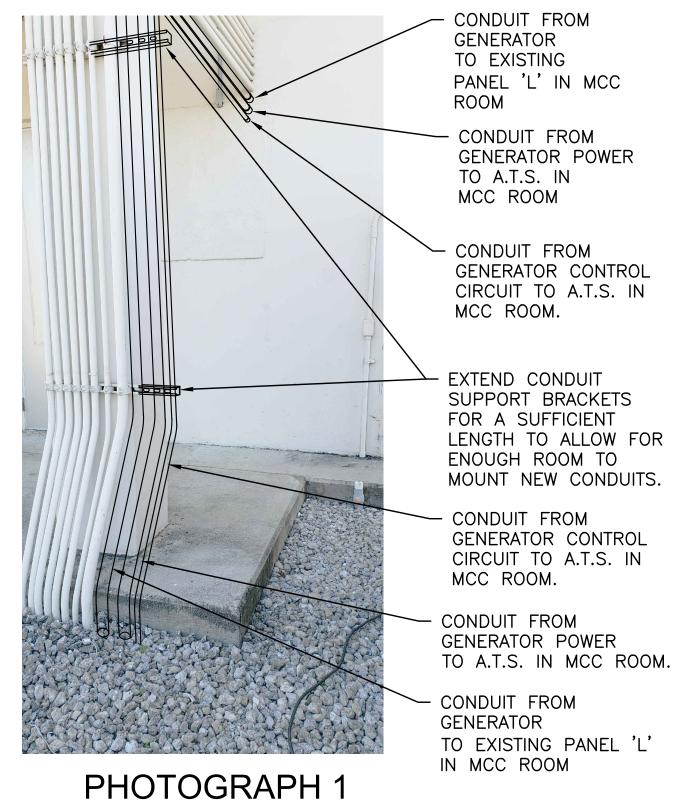

CONDUIT SUPPORT BRACKETS SCALE: N.T.S.

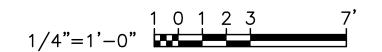

CONFIDENTIAL DOCUMENT NOT FOR PUBLIC DISCLOSURE In accordance with: FS Chapter 281.301 Chapter 119.071 (3)(b) NO. DATE REVISION FS Chapter 153

NOT MEASURE 1

12-11-20 DATE: WARNING SPH DESIGNED: SPH RAWN: THIS BAR DOES LMS LARRY M. SMITH, P.E. CHECKED: THEN DRAWING IS NO. 45997 NOT TO SCALE APPROVED:

West Palm Beach, Florida 33409 (561) 616-3911 fax (561) 616-3912

LOXAHATCHEE RIVER **ENVIRONMENTAL CONTROL DISTRICT**


HEADWORKS STANDBY GENERATOR UPGRADES AND IMPROVEMENTS


ELECTRICAL PARTIAL FLOOR PLAN

E-101

DRAWING NO.

SEC JOB NO. S20061

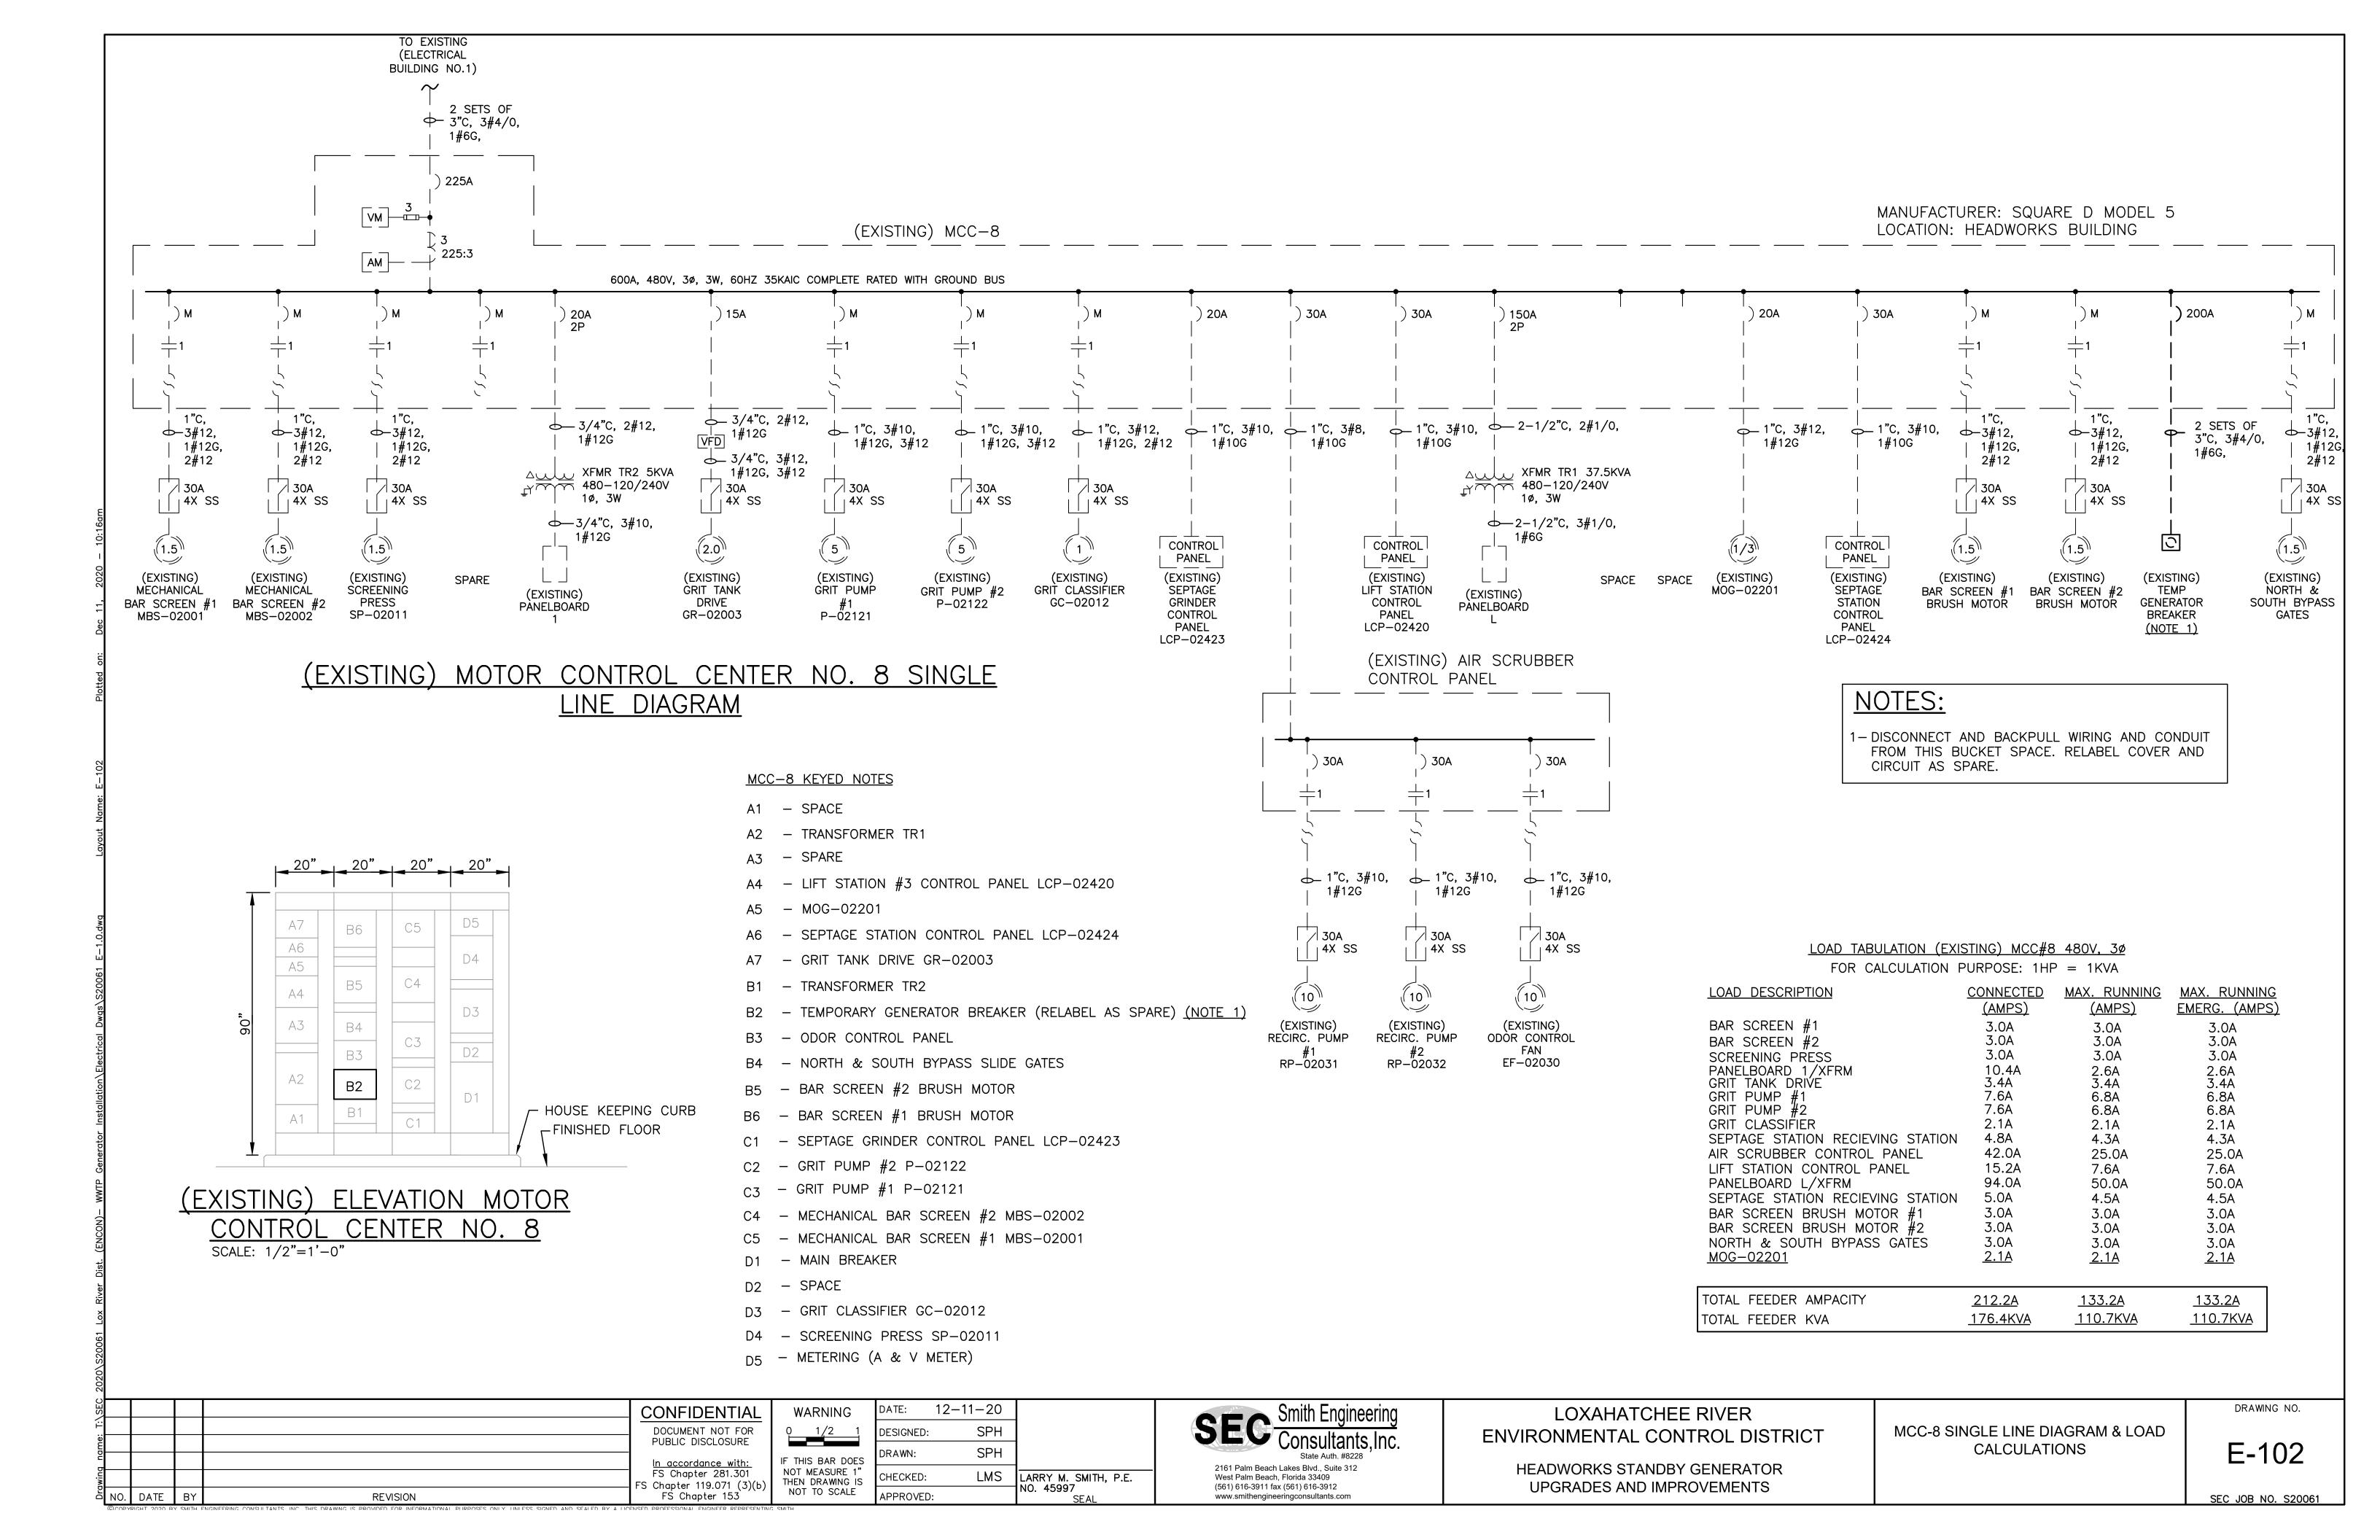

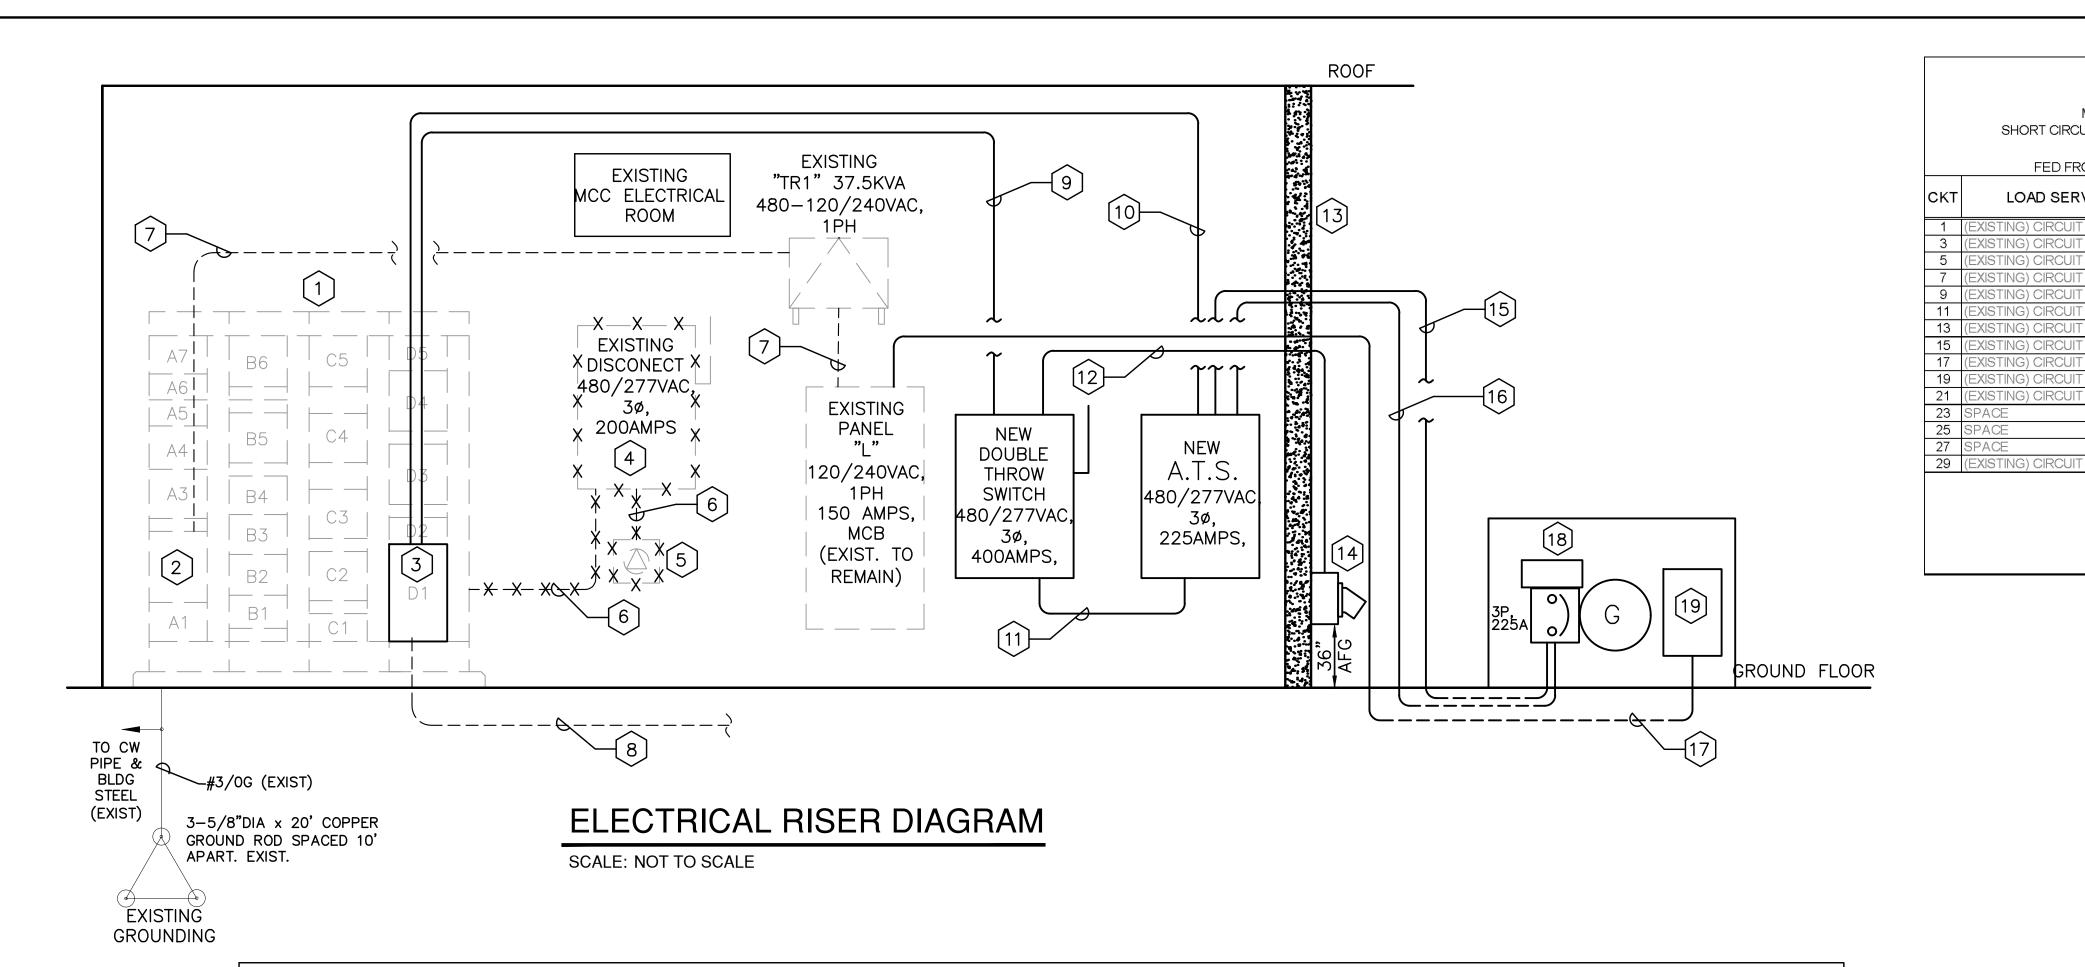

ELECTRICAL KEYED NOTES:

- [1] EXISTING MCC-8, 480/277VAC, $3\emptyset$, 3W IN EXISTING MCC ROOM TO REMAIN.
- 2 EXISTING TRANSFORMER 'TR1' BREAKER FEEDING EXISTING PANEL 'L' TO REMAIN.
- [3] EXISTING 225AMP BREAKER AND EXISTING 2 SETS OF 3#4/0, 1#6G IN EXISTING 3"C FEEDING FROM ON SITE MAIN ELECTRICAL BUILDING, SHALL REMAIN. INSTALL POLARIS TAP AHEAD OF THE BREAKER AT CONNECTION POINT INSIDE THIS MCC BUCKET TO CONNECT NEW WIRING FROM NEW 400AMP DOUBLE THROW SWITCH COMPLETE IN PLACE.
- 4 EXISTING DISCONNECT MOUNTED OUTSIDE MCC ROOM TO BE REMOVED. REMOVE ALL WIRING AND CONDUIT TO THE SOURCE.
- 5 EXISTING PORTABLE GENERATOR PLUG TO BE COMPLETELY REMOVED.
- 6 EXISTING WIRING, CONDUIT AND LB CONNECTORS TO BE REMOVED.
- (7) EXISTING WIRING AND CONDUIT FEEDING TRANSFORMER 'TR1' TO REMAIN
- (8) EXISTING CONDUIT AND CONDUCTORS (2 SETS OF 3#4/0, 1#6G IN EXISTING 3"C) FEEDING FROM ON SITE MAIN ELECTRICAL BUILDING TO REMAIN.
- 9 NEW 4-3/0, 1#2G IN 2"C FROM MCC-8 MAIN CIRCUIT BREAKER TO NEW DOUBLE THROW SWITCH.
- (10) NEW 4#3/0, 1#2G IN 2"C FROM MCC-8 MAIN CIRCUIT BREAKER TO NEW A.T.S. CONNECT TO EXISTING BUILDING SERVICE FEEDER VIA POLARIS TAPS.
- (11) NEW 4#3/0, 1#2G IN 2"C TO NEW DOUBLE THROW SWITCH.
- 14 NEW PORTABLE GENERATOR 225AMP PLUG MOUNTED ON OUTSIDE COLUMN AT 36" AFG. SEE SHEET E-101 FOR LOCATION. VERIFY RECEPTACLE WITH OWNER.
- 15 8-#14AWG FOR CONTROL WIRING FROM GENERATOR CONTROL PANEL TO A.T.S.
- 16 NEW 4#3/0, 1#2 GRND IN 2"C TO NEW A.T.S.
- (17) NEW 4#10, 1#10 G IN 1"C TO FEED GENERATOR BATTERY CHARGER AND JACKET WATER HEATER.

FS Chapter 153

(18) NEW DIESEL STANDBY GENERATOR, 130KW, (163KVA) 480/277V, 3ø, 4 WIRE, DIESEL, WITH TIME DELAY, WITH SUB BASE FUEL TANK AND WEATHER ENCLO (OWNER-FURNISHED, CONTRACTOR TO INSTALL)

APPROVED:

(19) NEW GENERATOR CHARGER AND JACKET WATER CONNECTION POINT. VERIFY EXACT I

LOXAHATCHEE RIVER

ELECTRICAL RISER DIAGRAM & PANEL SCHEDULES

DRAWING NO. E-103

SEC JOB NO. S20061

	ENERAC POWER N GENERATOR EI		(OWNER-	-FURNISHE
2-11-20		6		Smith Eng
SPH		8		Consulta
SPH				State Auth.
LMS	LARRY M. SMITH, P.I	 2161 Palm Beach Lakes Blvd., Suite West Palm Beach, Florida 33409 (561) 616-3911 fax (561) 616-3912		
	NO. 45997 SEAL		` '	eeringconsultants.co

ENVIRONMENTAL CONTROL DISTRICT

HEADWORKS STANDBY GENERATOR **UPGRADES AND IMPROVEMENTS**

CONFIDENTIAL DOCUMENT NOT FOR PUBLIC DISCLOSURE In accordance with: FS Chapter 281.301 Chapter 119.071 (3)(b)

REVISION

DATE

DATE: 12 WARNING DESIGNED: RAWN: NOT MEASURE 1 CHECKED: THEN DRAWING IS NOT TO SCALE

(12) NEW 4#3/0, 1#2G IN 2"C TO NEW GENERATOR PLUG. 13 EXISTING COLUMN.

(110.7KVA) =<u>110.7KVA</u> $110,700 \text{ VA} / (480 \text{V} \times 1.73) = 133.1 \text{ AMPS}$

MCC-8

THEREFORE THE 130KW (163KVA), 225A GENERATOR BREAKER IS ADEQUATE.

GENERATOR CALCULATIONS (480/277V, 3Ø, 3W)

PANEL "L"

9.0

CONNECTED AMPS = 38.0 | 39.0 | 49.5 | 36.5

TOTAL CONNECTED AMPS = 87.5 75.5

MOUNTING: SURFACE

FED FROM PANEL: MCC-8 VIA TRANSF. 'TR-1'

POLES: 30

SHORT CIRCUIT RATING: 42K AIC

LOAD SERVED

VOLT: 240/120V,1Ø,3W

(1) MAX 3% VD ON BRANCH CIRCUITS AS PER FBC

MAIN BUS AMPS: 225 A

MAIN BREAKER AMPS: 150


COND | WIRE | TRIP | POLE


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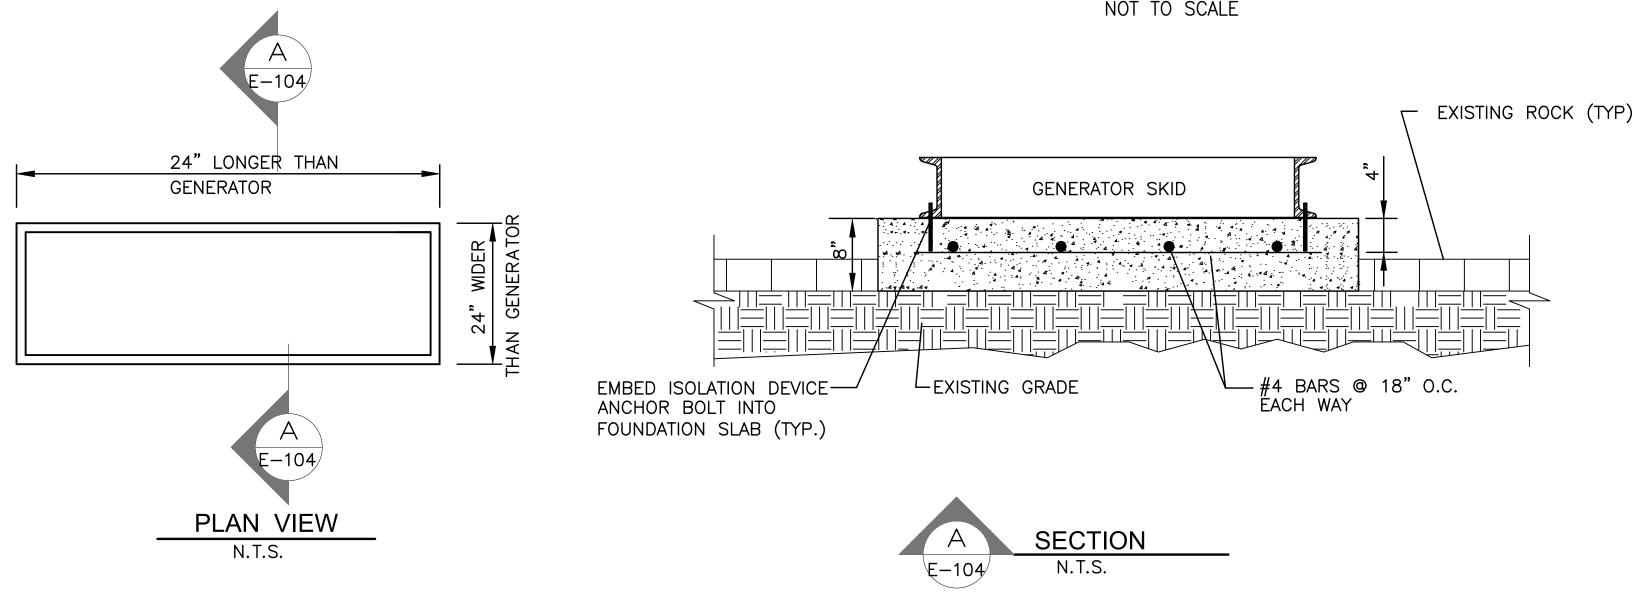
- 1. THE SCOPE OF WORK IS DESCRIBED IN THE DRAWINGS AND SPECIFICATIONS, PRIMARILY CONSIST OF THE FOLLOWING: 1.A. REMOVE EXISTING 200AMP GENERATOR DISCONNECT AND GENERATOR PLUG MOUNTED OUTSIDE EXISTING MCC ROOM.
- 1.B. INSTALL DISTRICT SUPPLIED 130KW DIESEL GENERATOR WITH SUB BASE FUEL TANK OUTSIDE OF EXISTING MCC ROOM.
- 1.C. INSTALL DISTRICT SUPPLIED A.T.S. INSIDE MCC ROOM.
- 1.D. PROVIDE AND INSTALL NEW DOUBLE THROW SWITCH INSIDE MCC ROOM.
- 1.E. PROVIDE AND INSTALL NEW PORTABLE GENERATOR PLUG ON COLUMN OUTSIDE MCC ROOM.

1.F. PROVIDE AND INSTALL NEW CONDUIT, PULL BOXES AND WIRING COMPLETE IN PLACE WHERE NEEDED.

- 2. THE CONTRACTOR SHALL PROVIDE ALL MATERIALS (WITH EXCEPTION OF DIESEL GENERATOR AND ATS) AND LABOR TO INSTALL
 THE ELECTRICAL SYSTEMS AS INDICATED ON THE DRAWINGS. ITEMS NOT SHOWN BUT NECESSARY FOR COMPLETION OF THE WORK
 SHALL BE INCLUDED.
- 3. THE INSTALLATION SHALL BE IN ACCORDANCE WITH THE 2014 NATIONAL ELECTRICAL CODE, 2017 (6TH EDITION) FLORIDA BUILDING CODE AND ALL LOCAL CODES. THE CONTRACTOR SHALL OBTAIN ALL NECESSARY PERMITS, INSPECTIONS AND APPROVALS AND SHALL COORDINATE HIS WORK WITH THE ENGINEER AND OWNER.
- 4. THE CONTRACTOR SHALL, BEFORE SUBMITTING HIS BID, VISIT THE SITE OF THE PROJECT AND BECOME FAMILIAR WITH THE EXISTING CONDITIONS. NO ALLOWANCE WILL BE MADE FOR EXISTING CONDITIONS OR FAILURE OF THE CONTRACTOR TO OBSERVE THEM.
- 5. GROUNDING SHALL BE INSTALLED IN ACCORDANCE WITH NEC, ARTICLE 250. THE GROUNDING SYSTEM TEST SHALL NOT EXCEED A 48 HOUR SPAN DRY RESISTANCE OF 10 OHMS. ADDITIONAL GROUNDING TO MEET THIS REQUIREMENT SHALL BE INSTALLED AT NO EXTRA COST. GROUNDING AND BONDING CONNECTIONS SHALL NOT BE PAINTED. AN EQUIPMENT GROUND WIRE SIZED PER NEC SHALL BE PULLED IN ALL ELECTRICAL CONDUITS. POWER AND CONTROL. WHETHER OR NOT INDICATED ON THE PLANS.
- 6. ALL NEW EQUIPMENT AND MATERIAL SHALL BE UNUSED AND U.L. LISTED.
- 7. THE CONTRACTOR IS RESPONSIBLE TO TEST ALL SYSTEMS AND REPAIR OR REPLACE ALL DEFECTIVE WORK TO THE SATISFACTION OF THE ENGINEER AND OWNER.
- 8. ALL EQUIPMENT FURNISHED AND INSTALLED BY THE CONTRACTOR SHALL BE GUARANTEED AGAINST DEFECTS IN MATERIAL AND WORKMANSHIP FOR A PERIOD OF ONE YEAR FROM DATE OF SUBSTANTIAL ACCEPTANCE.
- 9. COORDINATE ALL ELECTRICAL EQUIPMENT LOCATIONS AND VERIFY ALL OBSTRUCTIONS WITH ALL SUBCONTRACTORS AND EQUIPMENT SUPPLIERS PRIOR TO ANY INSTALLATION. THE DRAWINGS ARE NOT INTENDED TO SHOW THE EXACT LOCATION OF CONDUIT RUNS. THESE ARE TO BE COORDINATED WITH THE OTHER TRADES SO THAT CONFLICTS ARE AVOIDED PRIOR TO INSTALLATIONS.
- 10. ALL CONDUCTORS SHALL BE 600V, U.L. LISTED. POWER CABLES SHALL BE TYPE THHW/THWN. ALL CONDUCTING MEDIA SHALL BE COPPER. NO ALUMINUM ALLOWED.
- 11. ALL CIRCUITS SHALL BE IDENTIFIED IN JUNCTION BOXES, CONTROLLERS AND PANELBOARDS. IDENTIFICATION SHALL MATCH PANELBOARD SCHEDULES. EXPOSED RUNS OF CONDUITS SHALL BE INSTALLED WITH RUNS PARALLEL OR PERPENDICULAR TO WALLS, STRUCTURAL MEMBERS OR INTERSECTIONS OF VERTICAL PLANES AND CEILINGS, WITH RIGHT ANGLE TURNS CONSISTING OF SYMMETRICAL BENDS OR PULL BOXES AS INDICATED ON THE DRAWINGS. BENDS AND OFFSETS SHALL BE AVOIDED WHERE POSSIBLE.
- 12. ALL REFERENCES TO A PARTICULAR MANUFACTURER ARE GIVEN ON AN "APPROVED EQUAL" BASIS.
- 13. CONDUCTOR PULLING TENSIONS SHALL NOT EXCEED MANUFACTURER'S RECOMMENDATION. CONTRACTOR SHALL INSTALL PULL BOXES TO MEET MANUFACTURER'S REQUIREMENTS.
- 14. MINIMUM DISTANCE ALLOWED BETWEEN POWER CONDUITS AND INSTRUMENTATION CONDUITS SHALL BE: VOLTAGE DISTANCE
 480V 2 FT
 120V 1 FT
- 15. ALL LOCATIONS OF EQUIPMENT, PANELS ETC. ARE SHOWN FOR ILLUSTRATION PURPOSES. CONTRACTOR SHALL VERIFY EXACT LOCATION AND SIZE AND INSTALL AS SUCH WITH CORRESPONDING CONDUIT STUB-UPS.
- 16. THE CONTRACTOR SHALL BE RESPONSIBLE FOR ALL CONDUIT AND WIRING INSTALLATION FOR ALL VENDOR PROVIDED EQUIPMENT (PACKAGE SYSTEMS) INCLUDING OWNER SUPPLIED AND USER—CHOICE PANELS. IF THE SHOP DRAWINGS DIFFER FROM THE DESIGNED FACILITIES, THE CONTRACTOR SHALL REDESIGN THE FACILITIES AND SUBMIT THE REVISED DESIGN FOR THE ENGINEER'S APPROVAL ALONG WITH THE SHOP DRAWINGS. THERE SHALL BE NO ADDITIONAL COST TO THE OWNER FOR THE REDESIGN NOR FOR ANY ADDITIONAL CONDUITS AND WIRING.
- 17. PROVIDE DUCT SEAL IN ALL EXISTING AND NEW CONDUITS INSIDE SWITCHGEAR AND JUNCTION BOX.
- 18. DEMOLISH ALL ITEMS AS INDICATED ON DRAWINGS. TURN OVER TO THE OWNER AT THE OWNER'S DISCRETION AND PROPERLY DISPOSE OF ALL DEMOLITION ITEMS NOT WANTED BY THE OWNER.
- 19. ALL INSTALLATION AND EQUIPMENT SHALL COMPLY WITH N.E.C. STANDARD, EXCEPT IF OTHERWISE SHOWN IN DRAWINGS.
- 20. ALL CONDUIT PENETRATIONS SHALL BE AT THE BOTTOM OF ANY ENCLOSURE. SIDE PENETRATION IS ONLY ALLOWED WHEN CONNECTING SURGE PROTECTIVE DEVICE (SPD) AND PANEL AND AS INDICATED ON DRAWINGS.
- 21. ALL MOUNTING HARDWARE SHALL BE 316 STAINLESS STEEL.
- 22. CONTRACTOR SHALL, WITHIN 30 DAYS AFTER THE DATE OF THE SYSTEM ACCEPTANCE, PROVIDE TO THE BUILDING OWNER RECORD DRAWINGS OF THE ACTUAL INSTALLATION INCLUDING A SINGLE LINE DIAGRAM OF THE ELECTRICAL DISTRIBUTION SYSTEM AND RELATED FLOOR PLANS INDICATING THE LOCATION AND AREA SERVED FOR THE DISTRIBUTION.
- 23. CONTRACTOR SHALL PROVIDE TO THE BUILDING OWNER AN OPERATING AND MAINTENANCE MANUAL IN ACCORDANCE WITH THE REQUIREMENTS OF SECTION C405.6.4.2 OF THE 2017 FLORIDA BUILDING CODE ENERGY CONSERVATION, INCLUDING ANY AMENDMENTS THERETO.
- 24. SHOP DRAWINGS SHALL BE SUBMITTED FOR ALL WIRE, CONDUIT, DISCONNECT SWITCHES AND MISCELLANEOUS EQUIPMENT AND MATERIAL.
- 25. ALL EXPOSED CONDUIT SHALL BE RIGID ALUMINUM. UNDERGROUND CONDUIT SHALL BE PVC SCHEDULE 40.



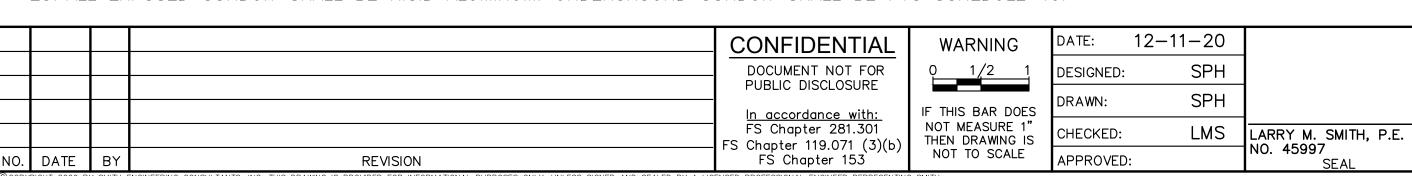

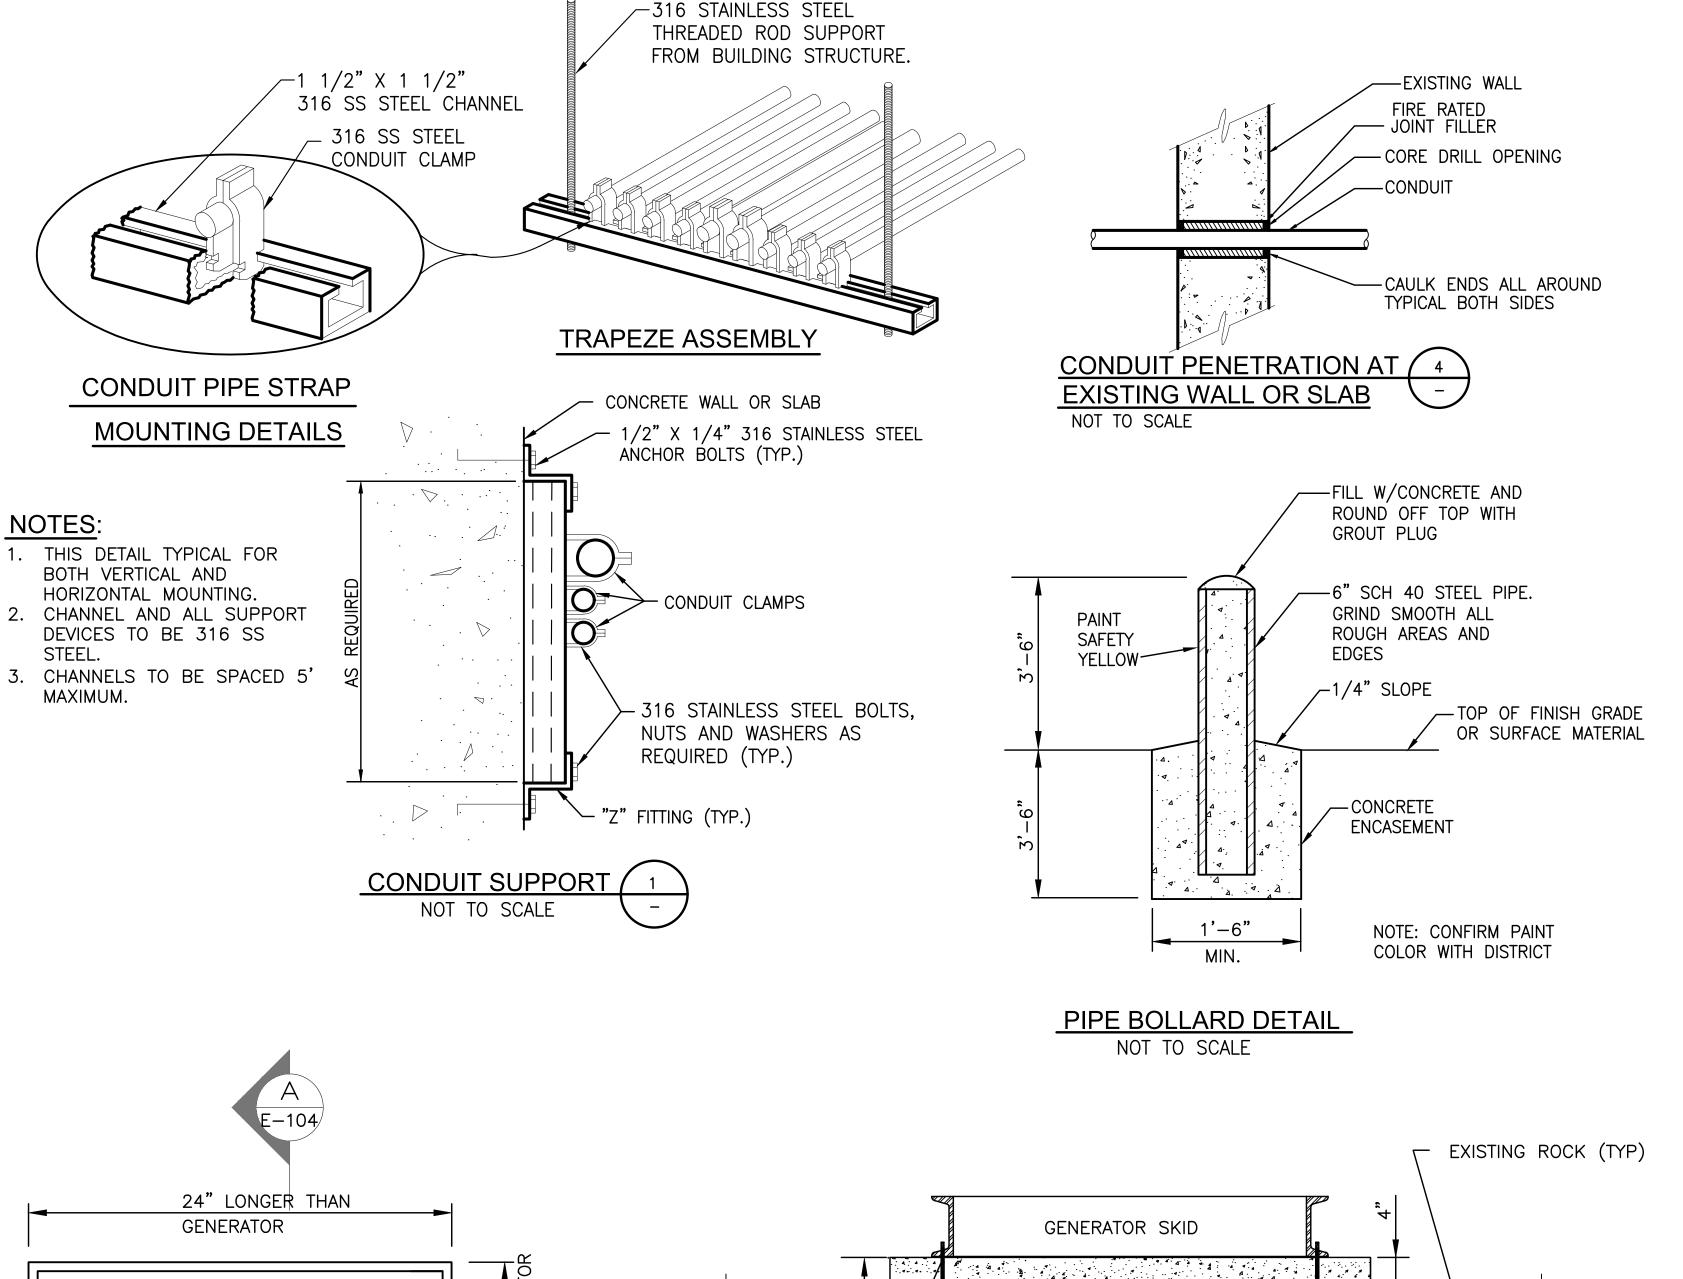

GENERATOR SIZE

DISTRICT SUPPLIED GENERATOR IS APPROXIMATELY 154"L X 40"W X 89"H. CONTRACTOR SHALL VERIFY DIMENSIONS PRIOR TO PROVIDING FOUNDATION SHOP DRAWING.

2161 Palm Beach Lakes Blvd., Suite 312

West Palm Beach, Florida 33409

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GENERATOR PAD DETAIL

NOT TO SCALE

WINDLOAD NOTE FOR GENERATOR

GENERATOR FOUNDATION AND MOUNTING SHALL BE SUITABLE FOR WIND LOAD IN ACCORDANCE WITH THE FLORIDA BUILDING CODE. THE CONTRACTOR SHALL INCLUDE WITH THE SHOP DRAWING SUBMITTAL, A WIND LOADING CALCULATION SEALED BY A STRUCTURAL ENGINEER REGISTERED IN FLORIDA SHOWING THAT THE PROPOSED INSTALLATION WILL MEET THE WIND LOADING REQUIREMENT.

LOXAHATCHEE RIVER
ENVIRONMENTAL CONTROL DISTRICT

HEADWORKS STANDBY GENERATOR
UPGRADES AND IMPROVEMENTS

ELECTRICAL SPECS & DETAILS

E-104

DRAWING NO.

SEC JOB NO. S20061