
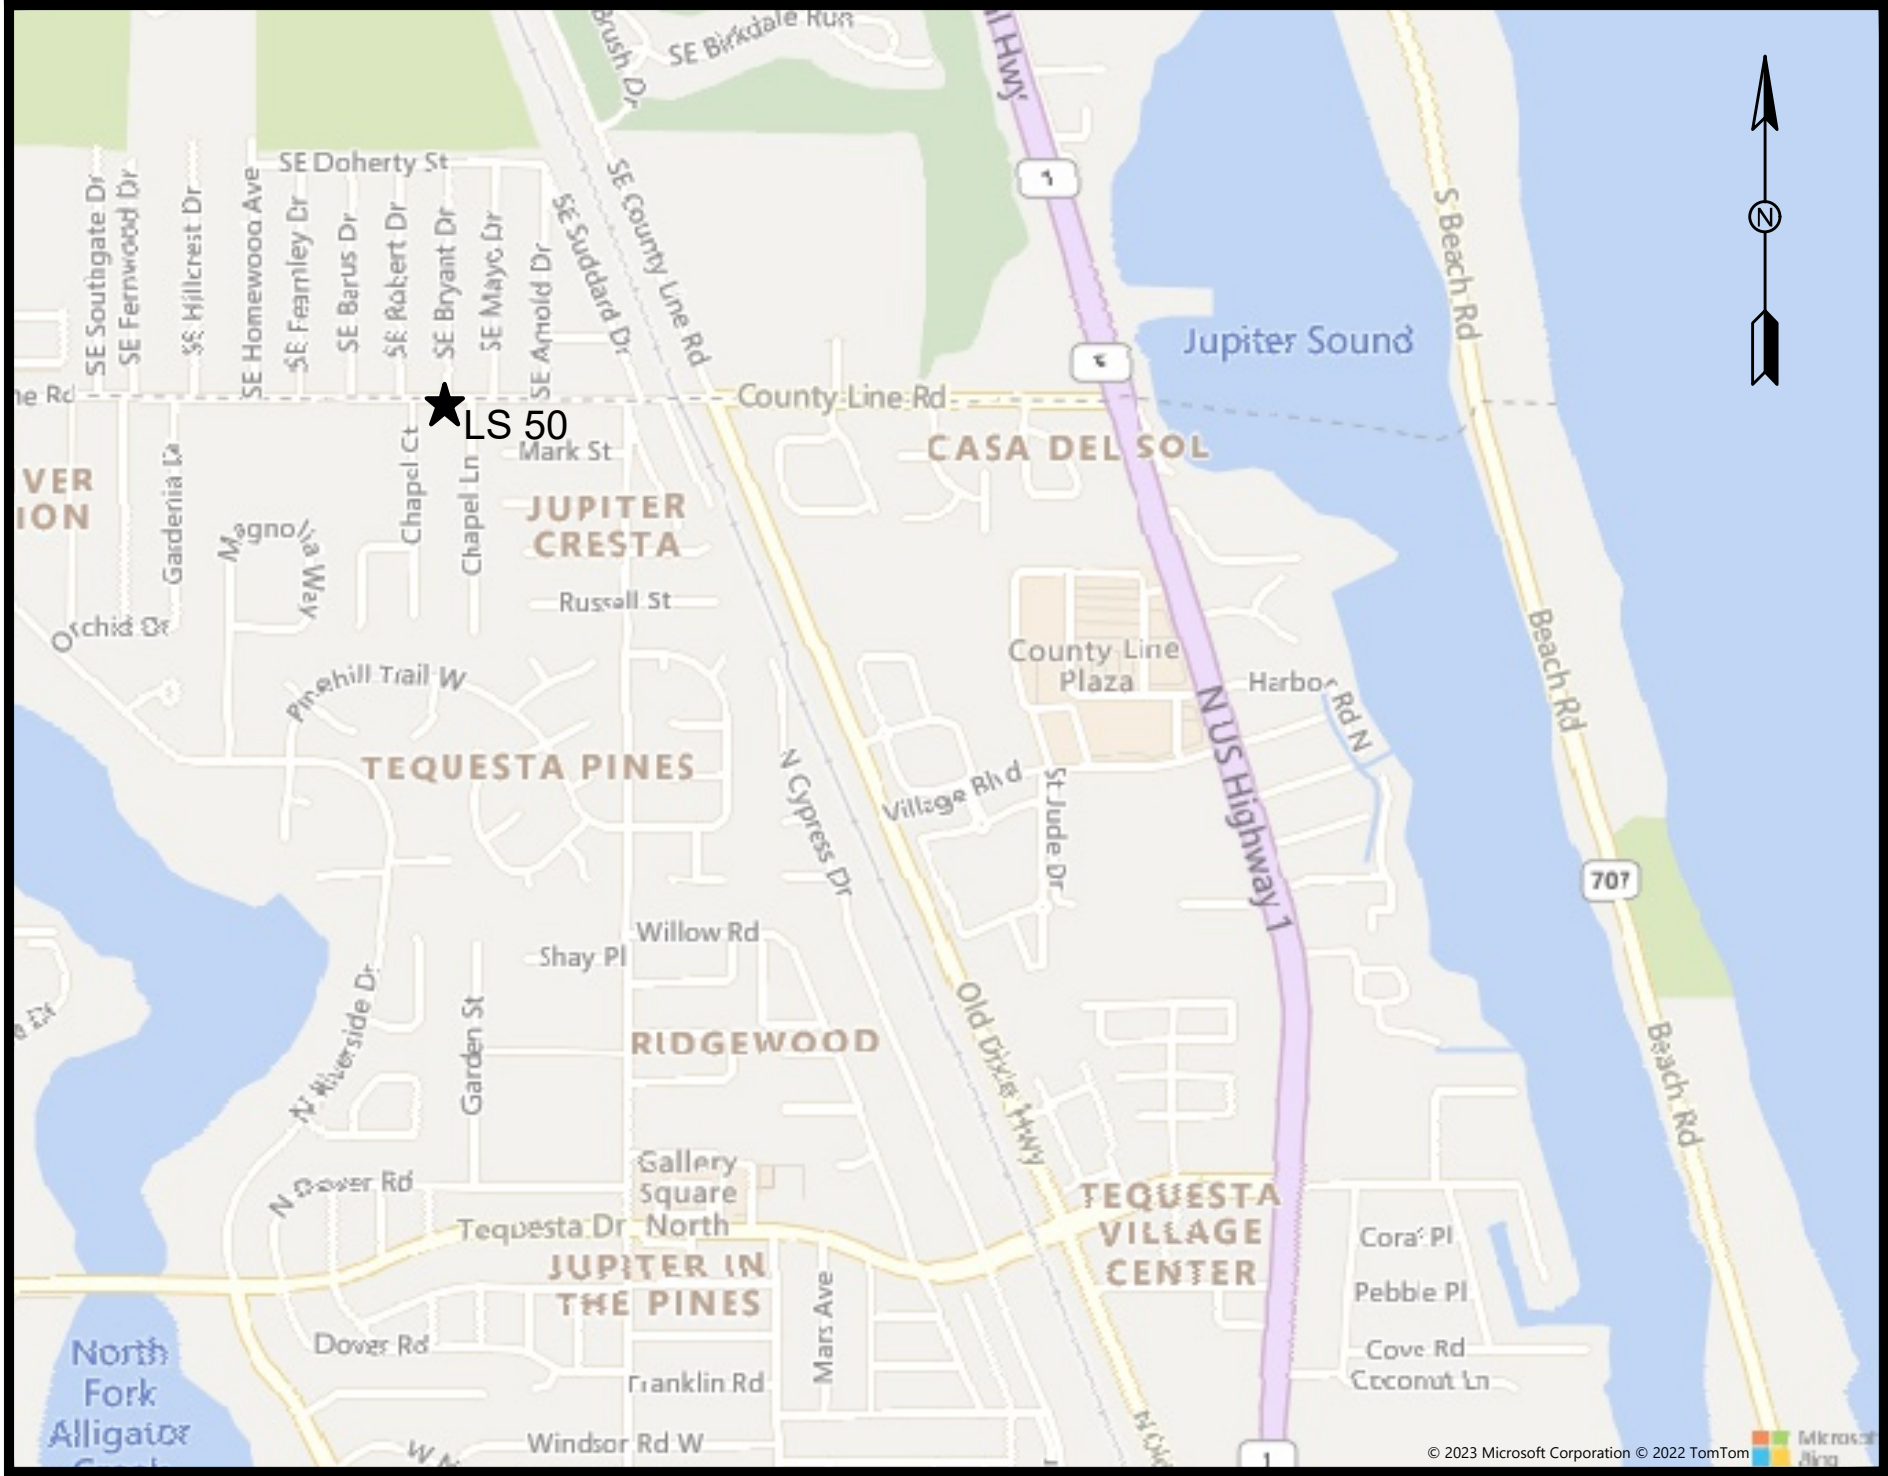


LIFT STATION NO. 50  
EMERGENCY GENERATOR PROJECT  
PREPARED FOR  
LOXAHATCHEE RIVER DISTRICT

PALM BEACH COUNTY, FLORIDA  
SECTION 25, TOWNSHIP 40S, RANGE 42E  
LIFT STATION 50 ADDRESS: 4282 COUNTY LINE ROAD, JUPITER, FL.

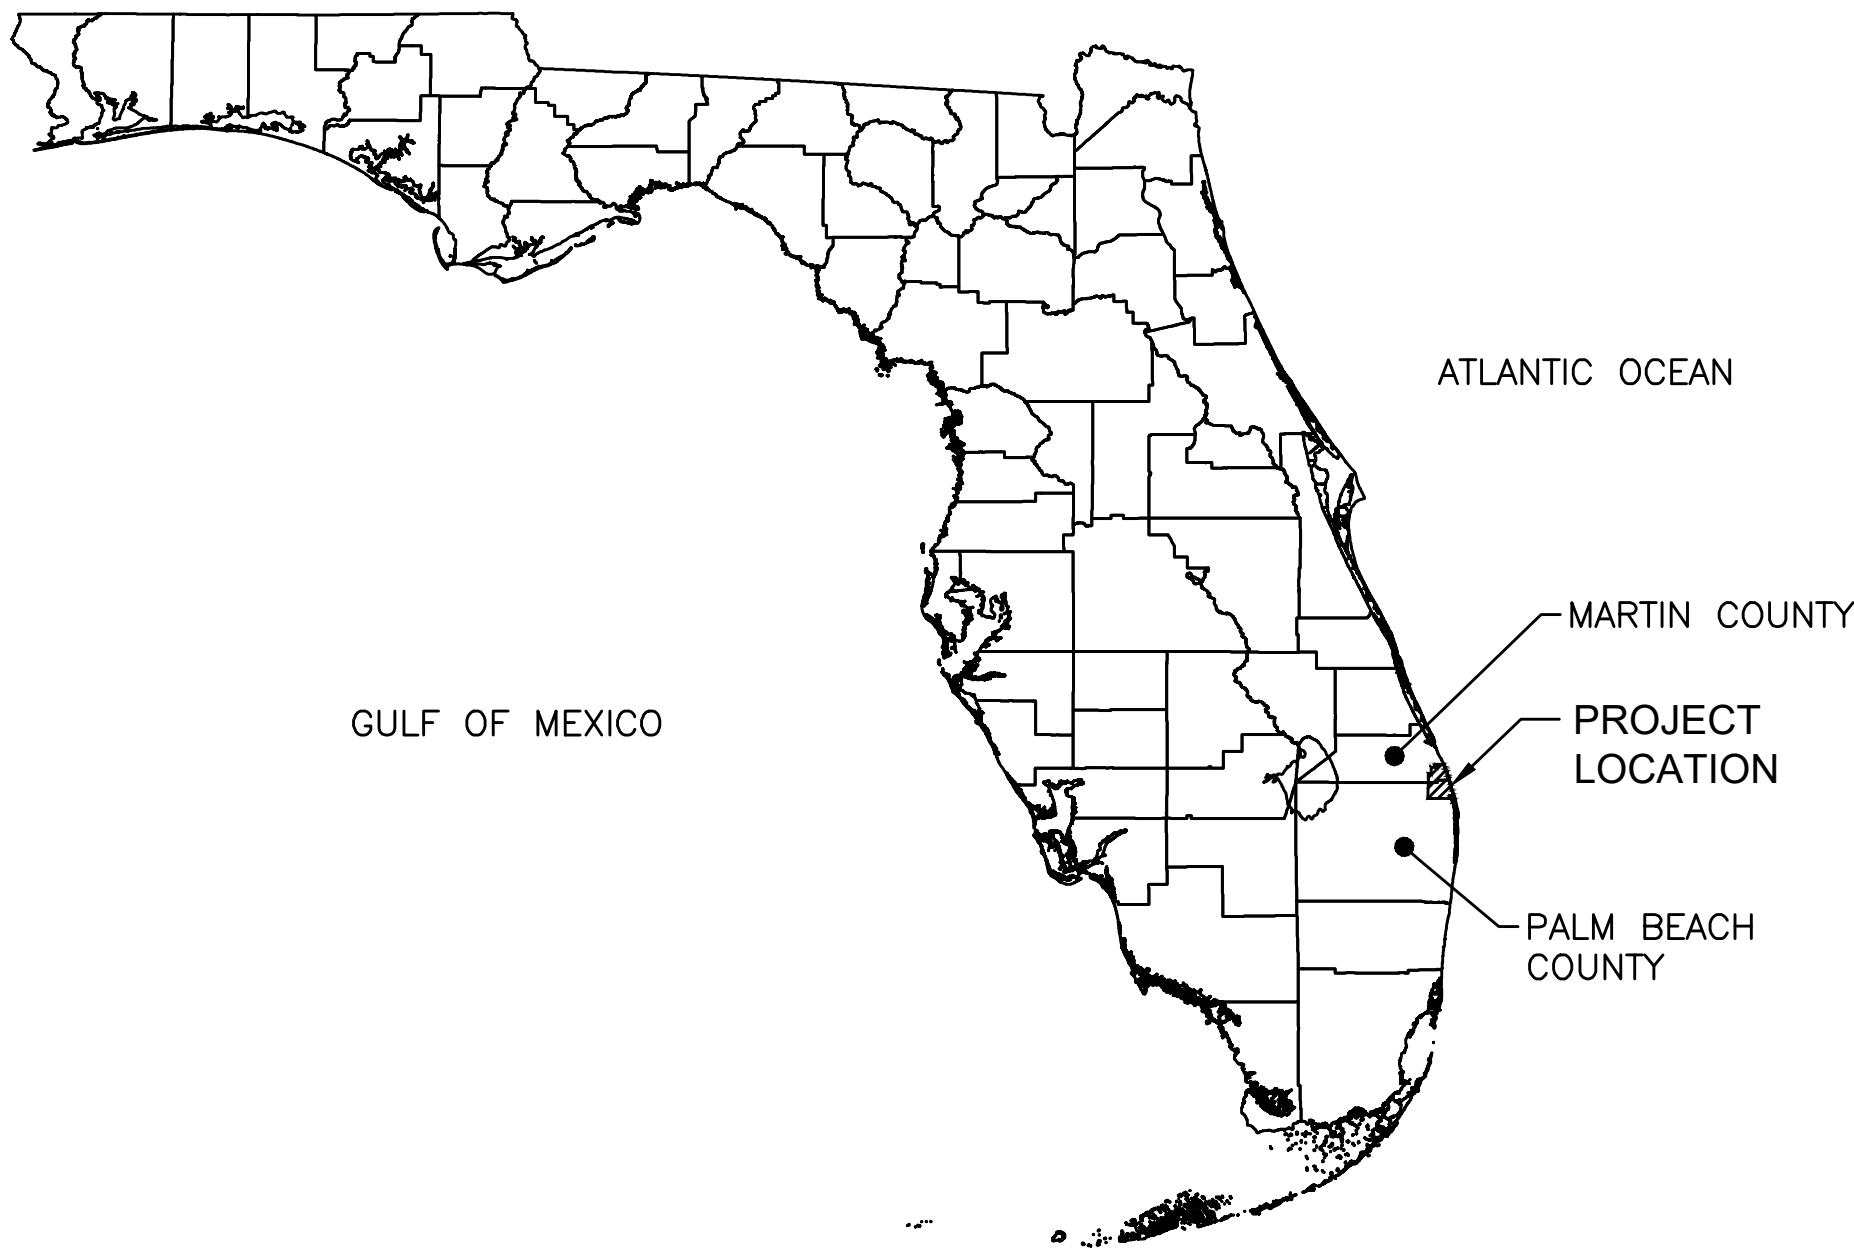

VICINITY MAP  
NTS

SHEET INDEX	
SHEET No.	SHEET TITLE
G-1	COVER
G-2	GENERAL NOTES AND LEGEND
C-1	LIFT STATION No. 50 DEMOLITION PLAN
C-2	LIFT STATION No. 50 SITE PLAN
D-1	CIVIL DETAILS
D-2	LIFT STATION DETAILS
E-1	ELECTRICAL NOTES & LEGEND
E-2	ELECTRICAL DEMOLITION SITE PLAN
E-3	ELECTRICAL INSTALL SITE PLAN
E-4	ELECTRICAL RISER DIAGRAM
E-5	GENERATOR ATS LOOP CHECK DETAIL
E-6	ELECTRICAL DETAILS



LOXAHATCHEE RIVER  
DISTRICT GOVERNING BOARD

STEPHEN B. ROCKOFF	CHAIRMAN
GORDON M. BOGGIE	VICE CHAIRMAN
CLINTON R. YERKES	TREASURER
KEVIN L. BAKER	SECRETARY
DR. MATT ROSTOCK	ASST. TREASURER

JUNE 2024

HOLTZ CONSULTING ENGINEERS, INC.  
**HCE** 270 SOUTH CENTRAL BLVD., SUITE 207  
JUPITER, FLORIDA 33458  
PH. (561) 575-2005  
Cert. No. 26960

CHRISTINE J. MIRANDA, P.E.  
License No. 60906

GENERAL ABBREVIATIONS

ABND	Abandon or Abandoned	MAX	Maximum
ACP	Asbestos Cement Pipe	MB	Mailbox
ADD'L	Additional	MECH	Mechanical
AL, Alum	Aluminum	MH	Manhole
APPROX	Approximate	MIN	Minimum
ARV	Air Release Valve	MISC	Miscellaneous
ASP, Asph	Asphalt	MJ	Mechanical Joint
BFP	Backflow Preventer	N/D	Nail and Disk
BFV	Butterfly Valve	NAVD	North American Vertical Datum
B/L	Base Line	NGVD	National Geodetic Vertical Datum
BLDG	Building	No	Number
BM	Benchmark	NTS	Not to Scale
BO	Blowoff	OC,O/C	On Center
BOP	Bottom of Pipe	OD	Outside Diameter
CATV	Cable Television	OHW	Overhead Wire
CB	Catch Basin	ORB	Official Records Book
CO	Cleanout	PB	Plat Book
CL	Center Line	PGL	Profile Grade Line
CLF	Chain Link Fence	PVC	Polyvinyl Chloride/Polyvinyl Chloride Pipe
CIP	Cast Iron Pipe / Cast in Place	RC	Reinforced Concrete
CMP	Corrugated Metal Pipe	RCP	Reinforced Concrete Pipe
CONC	Concrete	RCW	Reclaimed Water
CONST	Construct/Construction	RED	Reducer
DE	Drainage Easement	REINF	Reinforce/Reinforced
DI	Ductile Iron	RJ	Restrained Joint
DIP	Ductile Iron Pipe	RWM	Raw Water Main
DIA	Diameter	R/W,ROW	Right of Way
DR	Dimensional Ratio/Drainage	S=	Slope (FT/FT)/(Rise/Run)
DWY	Driveway	SAN	Sanitary
EL	Elevation	SCH/SCHED	Schedule
EOP	Edge of Pavement	SEC	Section
ESMT	Easement	SF	Silt Fence
EOW	Edge of Water	SP	Sample Point
EX, EXIST	Existing	SS	Sanitary Sewer
FDOT	Florida Department of Transportation	STA	Station
FH	Fire Hydrant	TBM	Temporary Benchmark
FM	Force Main	TEMP	Temporary
FND	Found	TOB	Top of Bank
FNPT	Female Nominal Pipe Thread	TON	Top of Nut
FPL	Florida Power and Light	TOP	Top of Pipe
FW	Finished Water	TOS	Toe of Slope
GPS	Global Positioning System	TYP	Typical
GV	Gate Valve	UE	Utility Easement
HB	Hose Bibb	UEC	Underground Electric Conduit
HDD	Horizontal Directional Drill	UGE	Underground Electric
HDPE	High Density Polyethylene	UGT	Underground Telephone
HYD	Hydrant	UNK	Unknown
ID	Identification	W/	With (Combined Form)
INV	Invert/Invert Elevation	WF	Wood Fence
IRC	Iron Rod & Cap	WM	Water Main or Water Meter
IRR	Irrigation	WPB	Wire Pullbox
LAE	Limited Access Easement	WTP	Water Treatment Plant
LF	Linear Feet	WV	Water Valve
LP	Light Pole	WWTP	Waste Water Treatment Plant
LS	Lift Station		
LSA	Landscape Area		

SURVEY ABBREVIATIONS & LEGEND

(C) = CALCULATED	⬢	BENCHMARK
C.B.S. = CONCRETE BLOCK STRUCTURE	✱	PALM TREE WITH DIAMETER IN INCHES
C.M.B. = COMMISSIONERS' MINUTES BOOK	⊙	SANITARY MANHOLE
CMH = CONFLICT MANHOLE	⊠ sv	SANITARY VALVE WITH CONCRETE APRON
D.B. = DEED BOOK	⌒	WOOD POWER POLE
E = EAST		
I.P. = IRON PIPE		
I.R. = IRON ROD		
LB = LICENSED BUSINESS		
LS = LICENSED SURVEYOR		
(M) = MEASURED		
M.H.W. = MEAN HIGH WATER		
MON. = MONUMENT		
N = NORTH		
(P) = PLAT		
P.B.C.R. = PALM BEACH COUNTY RECORDS		
PCN = PARCEL CONTROL NUMBER		
PG. = PAGE		
P.R.M. = PERMANENT REFERENCE MONUMENT		
R.P.B. = ROAD PLAT BOOK		
S = SOUTH		
(S) = SURVEY		
SLP = STOP LIGHT POLE		
SMH = SANITARY MANHOLE		
SBTH = SOUTHERN BELL TELEPHONE MANHOLE		
STMH = STORM MANHOLE		
TB = TRAFFIC BOX		
TLP = TRAFFIC LIGHT POLE		
TV = TELEVISION		
W = WEST		
WP = WOOD POLE		
MUP = WOOD UTILITY POLE		

LINETYPES

	EXISTING*	PROPOSED*
CABLE TV	--- CATV --- CATV ---	
CENTER LINE	---	---
DRAIN	--- DR --- DR ---	--- DR --- DR ---
EASEMENT	---	---
ELECTRIC	--- E --- E ---	
FENCE	--- X --- X ---	--- X --- X ---
FIBER OPTIC	--- FOC --- FOC ---	--- FOC --- FOC ---
FIRE MAIN	--- FIRE --- FIRE ---	--- FIRE --- FIRE ---
FORCE MAIN	--- FM --- FM ---	--- FM --- FM ---
GAS	--- GAS --- GAS ---	
GUARDRAIL	---	---
IRRIGATION	--- IRR --- IRR ---	--- IRR --- IRR ---
OVERHEAD UTILITIES	--- OHU --- OHU ---	
RAILROAD TRACK	---	---
RAW WATER MAIN	--- RWM --- RWM ---	--- RWM --- RWM ---
RECLAIMED WATER MAIN	--- RCW --- RCW ---	--- RCW --- RCW ---
RIGHT-OF-WAY	---	---
SANITARY SEWER	--- S --- S --- S ---	--- S --- S --- S ---
SANITARY SEWER SERVICE	--- SS --- SS --- SS ---	--- SS --- SS --- SS ---
SILT FENCE	--- SF --- SF ---	--- SF --- SF ---
STORM DRAINAGE	--- ST --- ST --- ST ---	--- ST --- ST --- ST ---
TELEPHONE	--- T --- T --- T ---	
TOP OF BANK	---	---
TOE OF SLOPE	---	---
TRAFFIC SIGNAL	--- TS --- TS --- TS ---	--- TS --- TS --- TS ---
TURBIDITY BARRIER	---	---
UNKNOWN	--- UNK --- UNK ---	--- UNK --- UNK ---
VACUUM SEWER	--- VS --- VS --- VS ---	--- VS --- VS --- VS ---
WATER MAIN	--- WM --- WM ---	--- WM --- WM ---
WATER SERVICE	--- WS --- WS ---	--- WS --- WS ---
WOOD FENCE	--- WF --- WF ---	--- WF --- WF ---

\* DEPICTS ABOVE GRADE    --- TEXT --- TEXT --- TEXT ---  
\* DEPICTS BELOW GRADE    --- TEXT --- TEXT --- TEXT ---

PIPING SYMBOLOGY

	CONCENTRIC REDUCER
	ECCENTRIC REDUCER
	UNION
	BALL VALVE (BV)
	GATE VALVE (GV)
	BUTTERFLY VALVE (BFV)/ ODOR CONTROL DAMPENERS
	PLUG VALVE (PV)
	CHECK VALVE (CV)
	PLUG/CAP
	CLEAN OUT
	TAPPING VALVE
	LINE STOP
	HOSE BIBB
	EXISTING BURIED PIPE
	PROPOSED PIPE
	PROPOSED PIPE
	MECHANICAL JOINT
	FLANGE JOINT
	FLEXIBLE COUPLING
	FLEXIBLE COUPLING WITH THRUST TIES
	ELBOW UP
	ELBOW DOWN
	90° ELBOW
	TEE UP
	TEE DOWN
	TEE
	CROSS

CIVIL SYMBOLOGY

CONSTRUCTION BASE LINE	0+00
DIRECTION OF FLOW	→
EXIST. SPOT ELEVATION	x 79.5
PROP. SPOT ELEVATION	0.0
BENCHMARK	EL. 20.90
NEW CONTOUR ELEV.	79.5
EXIST. UTILITY POLES	UTILITY POWER TELEPHONE LIGHT
NEW UTILITY POLES	UTILITY POWER TELEPHONE LIGHT
PIPING CONFLICT LOCATION	C-1
SAMPLE POINT	SP1
WATER SURFACE	PLAN SECTION EL. 48.00
FIRE HYDRANT	NEW EXIST.
EXIST. MANHOLE, DRAINAGE STRUCTURE	○ □
NEW MANHOLE, DRAINAGE STRUCTURE	○ □
TO BE REMOVED/DEMOLISHED	▨

SECTION/DETAIL SYMBOL

SECTION	5	SECTION LETTER/DETAIL NUMBER
SCALE:	15	SHEET/DRAWING NO. ON WHICH SECTION/DETAIL IS SHOWN
SECTION CUT	1	SECTION LETTER/DETAIL NUMBER
	101	SHEET/DRAWING NO. ON WHICH SECTION/DETAIL IS SHOWN
SECTION CUT ON DETAILS		
PIPE DESIGNATION	8" DIP FORCE MAIN	
NOMINAL PIPE DIA.(IN.)		
PIPE MATERIAL (IF SHOWN)		
FLOW STREAM IDENTIFICATION (IF SHOWN)		

Symbols:

#	Pounds/Number
<	Angle
Ø	Round/Diameter



Know what's below.  
Call before you dig.

REV	DATE	REVISIONS	BY

VERIFY SCALE  
BAR IS EQUAL TO ONE  
INCH ON ORIGINAL DRAWING  
0 1  
ADJUST ALL SCALED  
DIMENSIONS ACCORDINGLY

Date: 6/11/24  
Scale: AS NOTED  
Design By: CM  
Drawn By: RR  
Check By: CM



LOXAHATCHEE RIVER DISTRICT  
LIFT STATION NO. 50  
EMERGENCY GENERATOR PROJECT

LEGEND


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HCE 270 SOUTH CENTRAL BLVD., SUITE 207  
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PH. (561) 575-2005  
Cert. No. 26960

CHRISTINE J. MIRANDA, P.E.  
License No. 60906

G-2

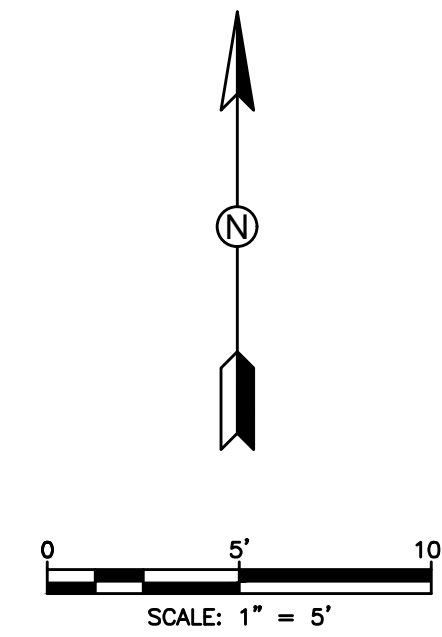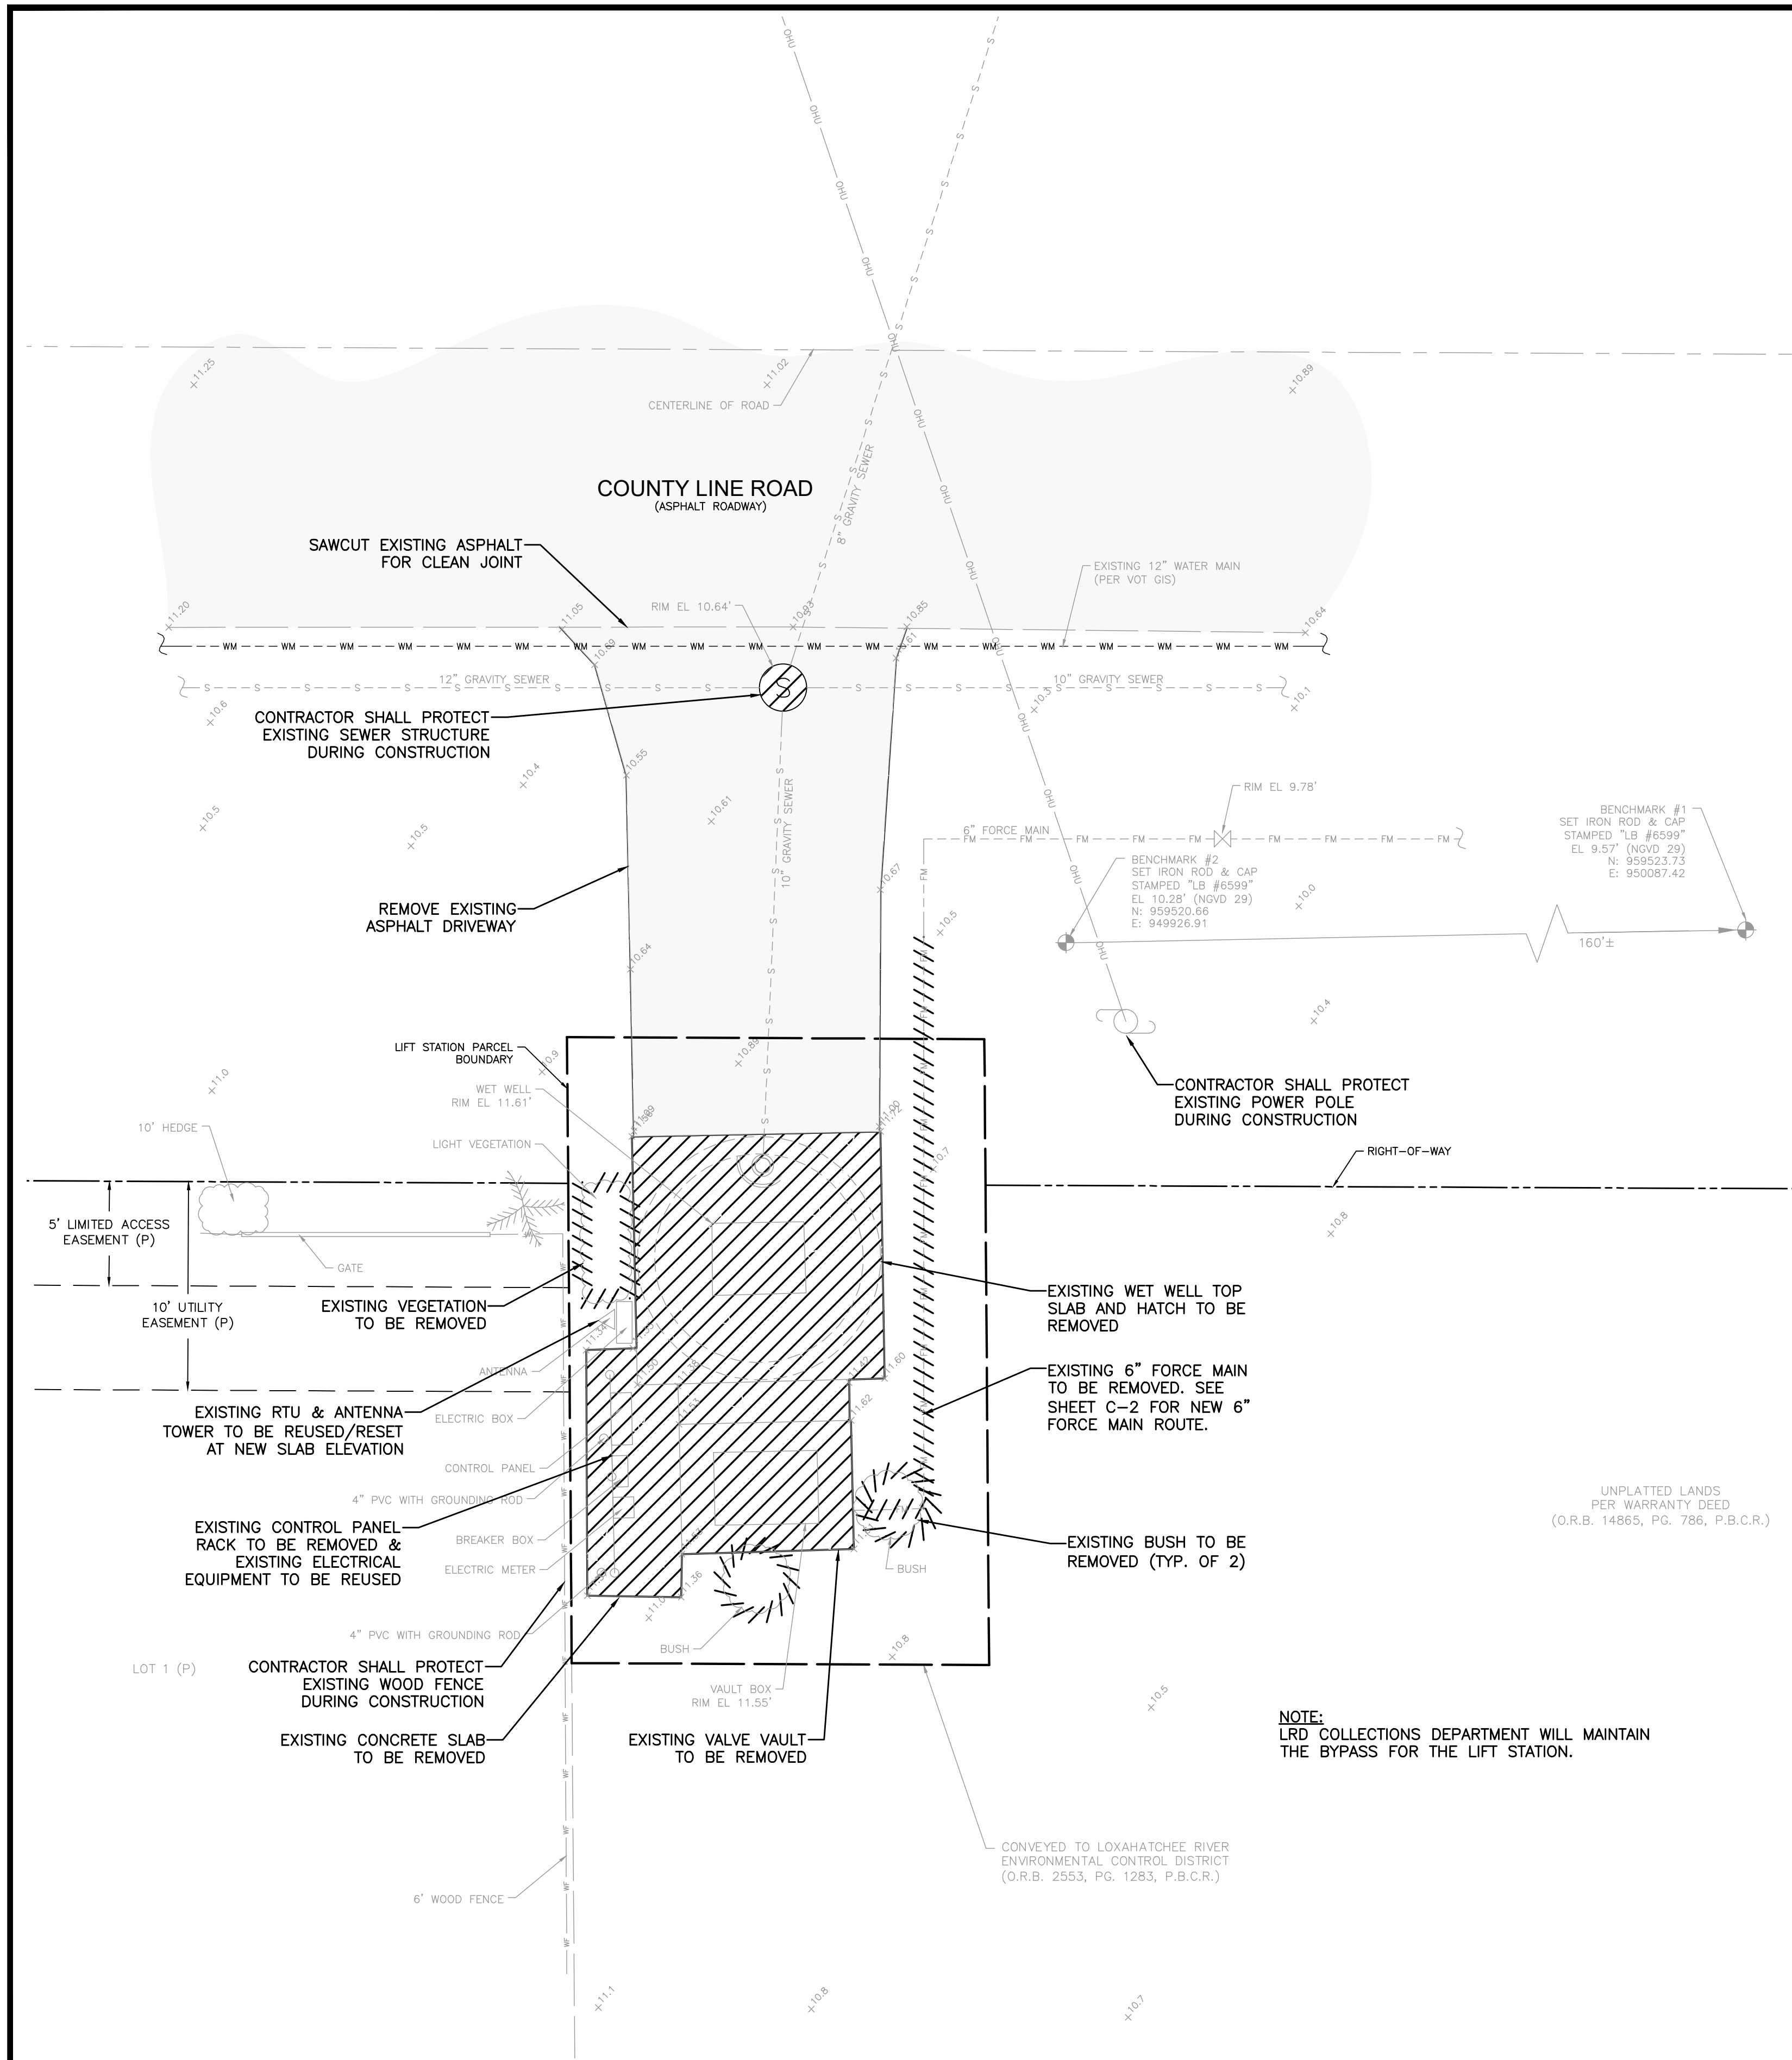

- NOTES:**
1. BY GRAPHIC PLOTTING ONLY THE SUBJECT PROPERTY LIES WITHIN ZONE X, AS SHOWN ON THE U.S. DEPARTMENT OF HOMELAND SECURITY FEDERAL EMERGENCY MANAGEMENT AGENCY (FEMA) FLOOD INSURANCE RATE MAP, MAP NUMBER: 12099C0180F, COMMUNITY: VILLAGE OF TEQUESTA, NUMBER: 120228, PANEL 0180, SUFFIX: F, EFFECTIVE DATE: OCTOBER 5, 2017.
  2. BENCHMARK OF ORIGIN: NGS BENCHMARKS "A 232" AND "B 170" WHOSE PUBLISHED ELEVATIONS ARE 15.92' AND 14.83' RESPECTIVELY, BASED ON THE NORTH AMERICAN VERTICAL DATUM OF 1988.
  3. ELEVATIONS REFERENCED HEREON ARE BASED ON THE NATIONAL GEODETIC VERTICAL DATUM OF 1929 (NGVD 29).
  4. TO CONVERT FROM NAVD 88 TO NGVD 29 ADD 1.529'.  
EXAMPLE: 10.00' (NAVD 88) = 11.529' (NGVD 29).
  5. MAINTAIN MINIMUM 4FT. HORIZONTAL CLEARANCE AND 1 FT. VERTICAL CLEARANCE FROM OUTSIDE ALL OF PALM BEACH COUNTY UTILITY STRUCTURES, CONDUITS, AND PIPES.

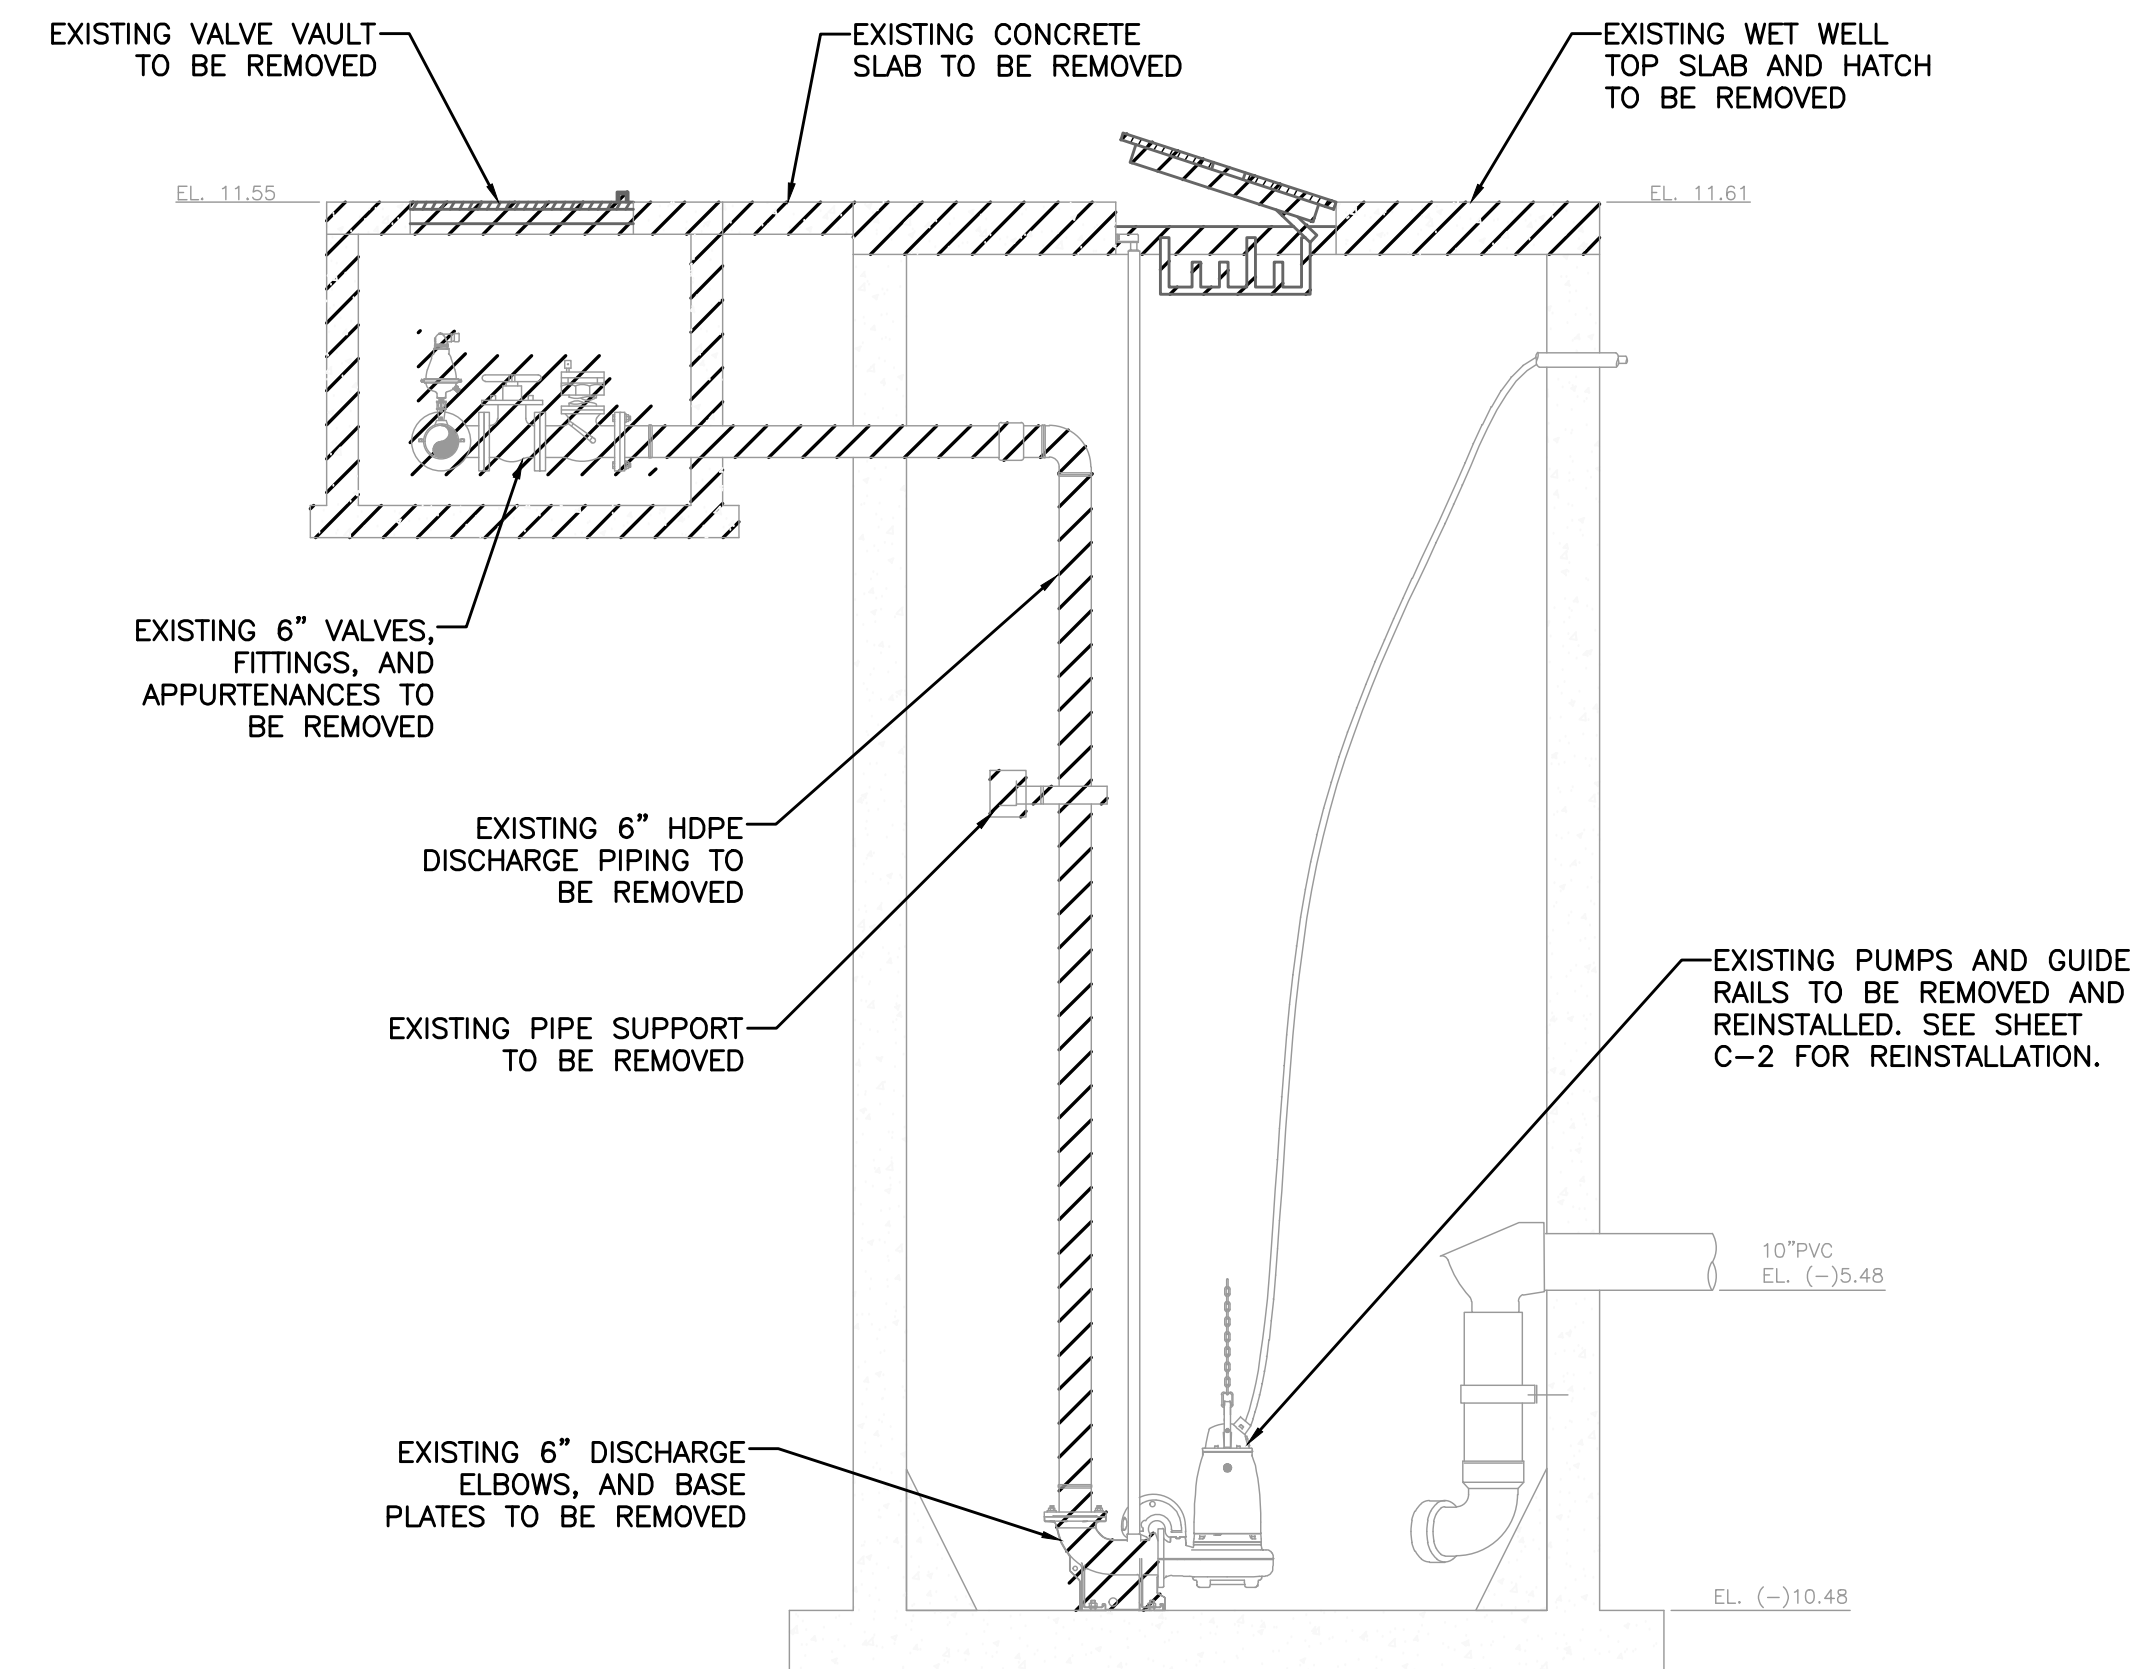

**EXISTING LIFT STATION PROFILE**  
SCALE: 1" = 3'

REV	DATE	REVISIONS	BY

VERIFY SCALE  
BAR IS EQUAL TO ONE  
INCH ON ORIGINAL DRAWING  
0 1  
ADJUST ALL SCALED  
DIMENSIONS ACCORDINGLY

Date: 6/11/24  
Scale: AS NOTED  
Design By: CM  
Drawn By: RR  
Check By: CM

LOXAHATCHEE RIVER DISTRICT  
LIFT STATION NO. 50  
EMERGENCY GENERATOR PROJECT

LIFT STATION NO. 50  
DEMOLITION PLAN

HOLTZ CONSULTING ENGINEERS, INC.  
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C-1

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CHRISTINE J. MIRANDA, P.E.	C-2
License No: 60906	

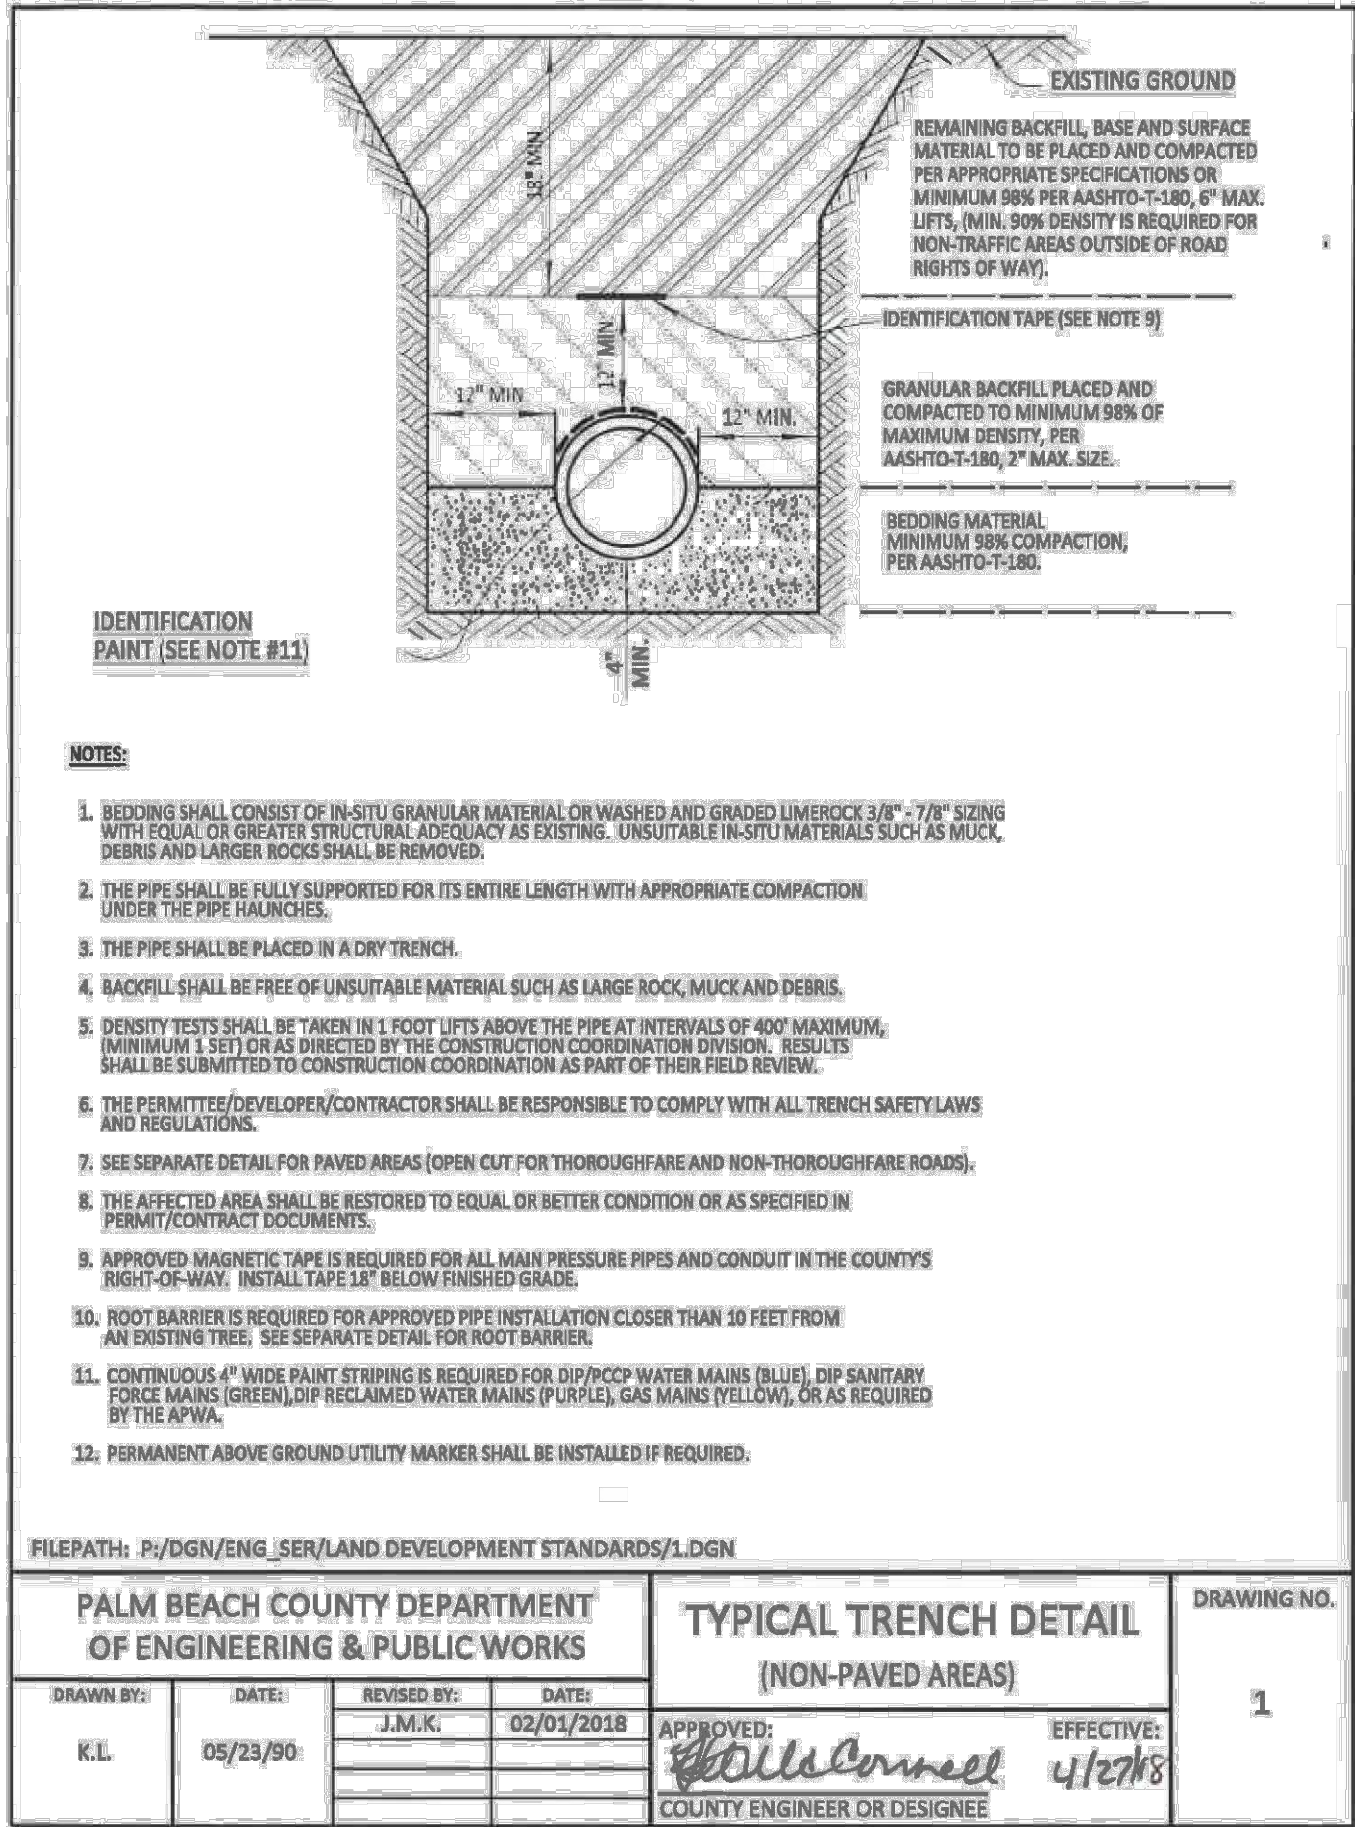


TABLE 100.6

TABLE OF MATERIALS AND CONSTRUCTION STANDARDS: RESIDENTIAL ACCESS AND LOCAL STREETS

Component (1)	Description of Materials	Construction Standards Minimum In Place		Notes
		Thickness (2)	SN (min.) (3)	
A	SP Structural Course	1 1/2"	0.66	Traffic Level A
B	Optional Base Group 9	See notes	1.65	Refer to FDOT Flexible Pavement Design Manual Table 5.6
C	Compacted Subgrade (5)	12"	0	
Total			2.31	

(1) A = Pavement  
B = Base  
C = Subgrade

(2) All Dimensions Refer to Finished Thickness

(3) Compacted to At Least 98% Maximum Density Per PER A.A.S.H.T.O. T-180.


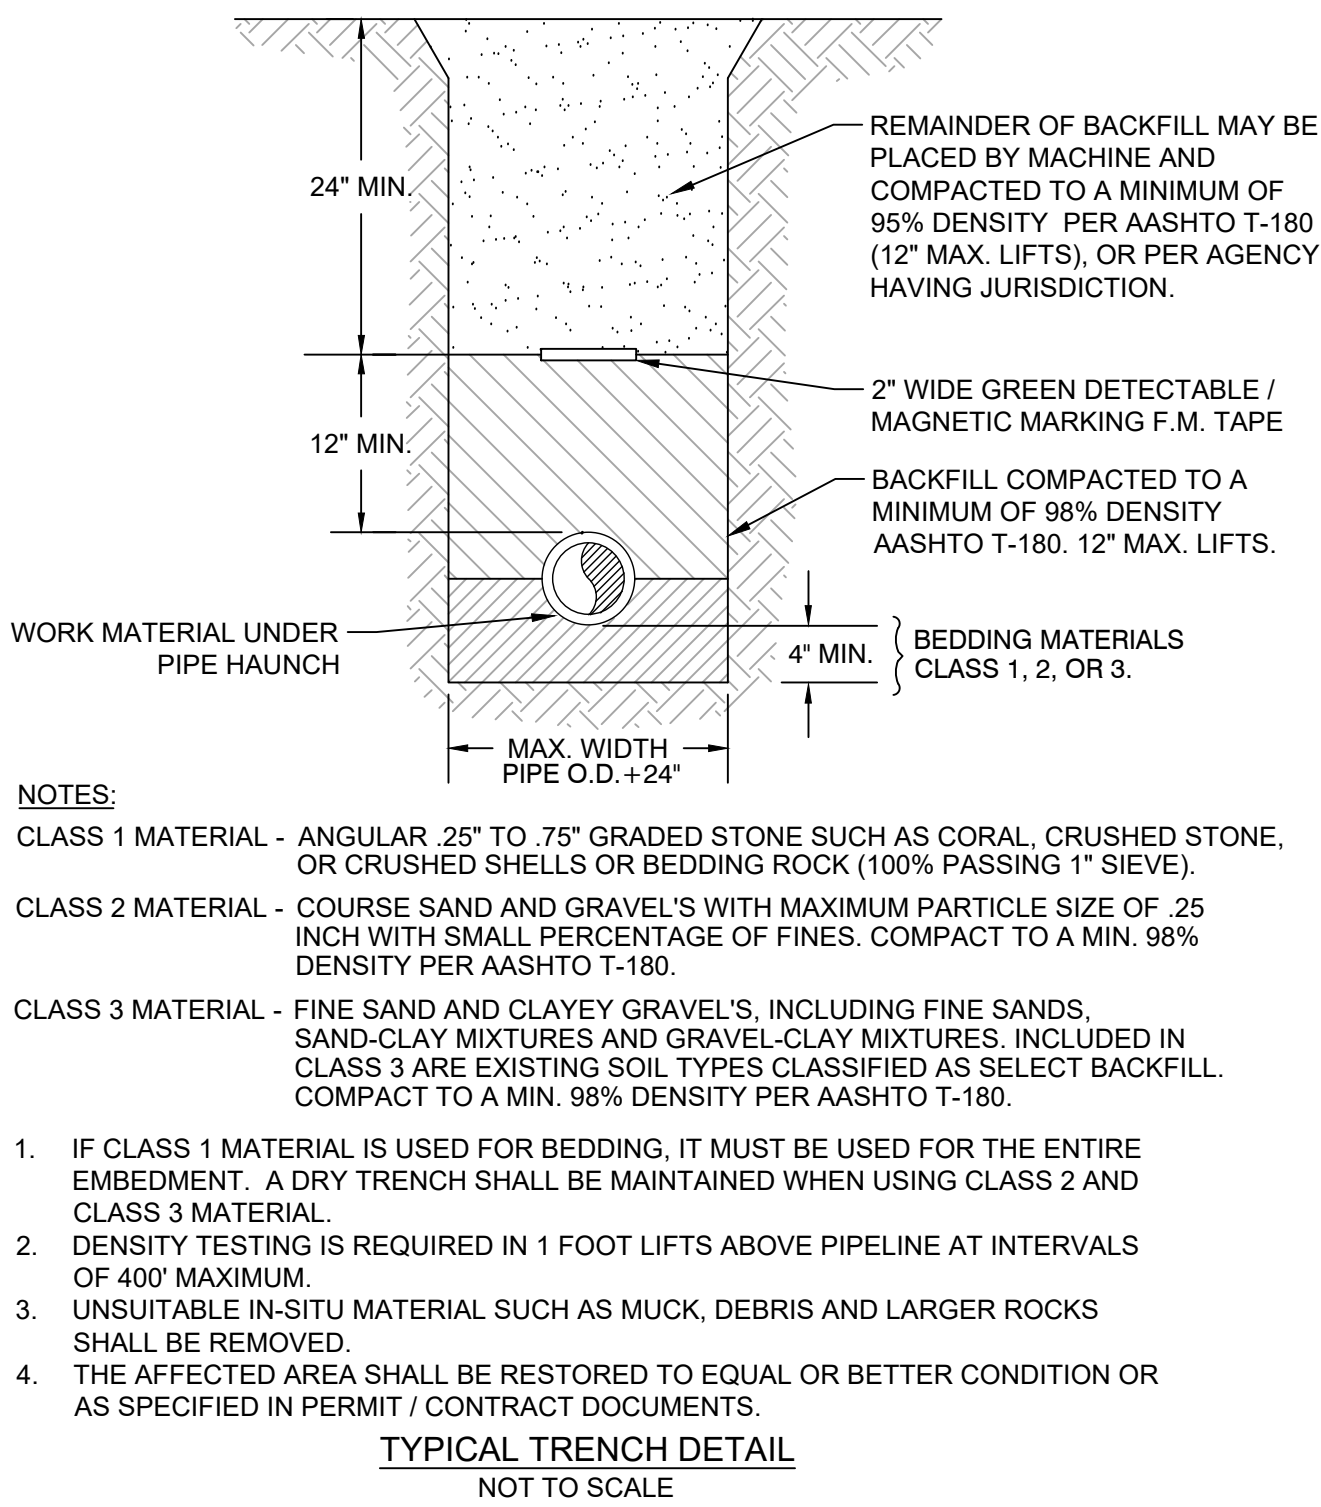
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PALM BEACH COUNTY DEPARTMENT OF ENGINEERING & PUBLIC WORKS

TABLE OF MATERIALS AND CONSTRUCTION STANDARDS: RESIDENTIAL ACCESS AND LOCAL STREETS

DRAWING 100.6

DRAWN BY: K.L. DATE: 05/23/90 REVISED BY: J.M.K. DATE: 02/01/2018 APPROVED: J. M. K. EFFECTIVE: 4/27/18 COUNTY ENGINEER OR DESIGNEE

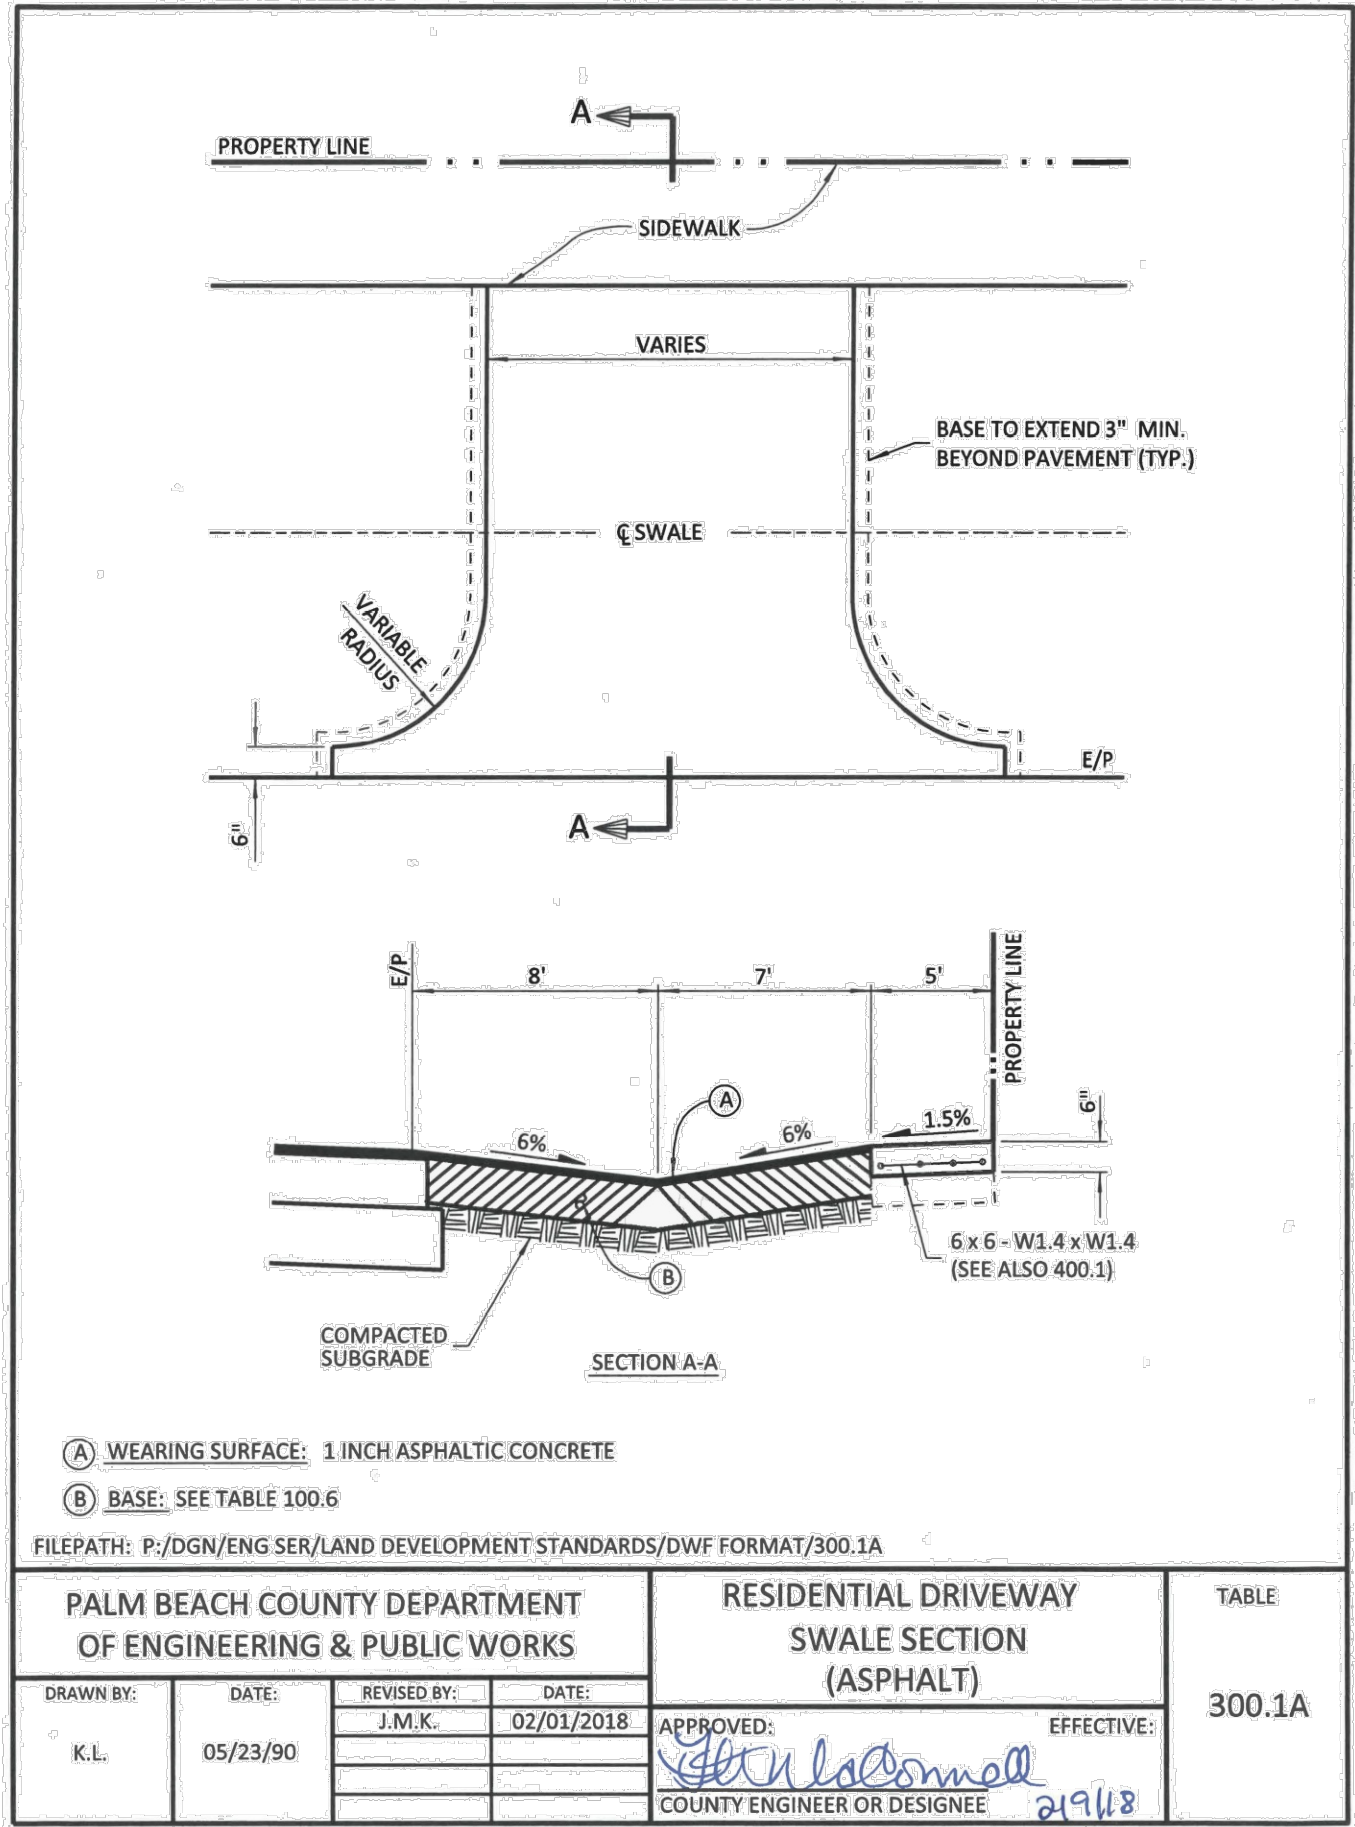

REV	DATE	REVISIONS	BY

VERIFY SCALE

BAR IS EQUAL TO ONE INCH ON ORIGINAL DRAWING

0 1

ADJUST ALL SCALED DIMENSIONS ACCORDINGLY

Date: 6/11/24

Scale: AS NOTED

Design By: CM

Drawn By: RR

Check By: CM

LOXAHATCHEE RIVER DISTRICT

LIFT STATION NO. 50

EMERGENCY GENERATOR PROJECT

CIVIL DETAILS

HOLTZ CONSULTING ENGINEERS, INC.

HCE

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CHRISTINE J. MIRANDA, P.E.

License No: 60906

D-1



GENERAL ELECTRICAL NOTES



1. **SCHEMATIC NATURE**  
PLAN VIEWS ARE SCHEMATIC IN NATURE AND MEANT TO SHOW THE SCHEMATIC ARRANGEMENT OF EQUIPMENT AND CONDUIT.
2. **APPROVED SHOP DRAWINGS**  
USE APPROVED SHOP DRAWINGS FOR LAY OUT OF EQUIPMENT. THE CONTRACT DOCUMENTS WILL VARY FROM THE SHOP DRAWINGS. INFORM THE ENGINEER IMMEDIATELY IF THERE ARE LAY OUT ISSUES OR INADEQUATE SPACE FOR EQUIPMENT OR CLEARANCES. LAND CONDUITS IN OPENINGS OF ENCLOSURES PER THE APPROVED SHOP DRAWINGS, DO NOT USE THE CONTRACT DRAWINGS.
3. **CLEARANCES**  
IT SHALL BE THE CONTRACTOR'S RESPONSIBILITY TO MEET N.E.C. CLEARANCES ABOUT EQUIPMENT. THE SAME APPLIES TO RACEWAY SUPPORTS.
4. **ROUTING**  
CONDUIT ROUTING IS SCHEMATIC IN NATURE. CONDUIT ROUTING IS SHOWN FOR CLARITY ON THE CONTRACT DRAWINGS. ROUTE CONDUITS AS MAY BE REQUIRED.
5. **FIELD VERIFICATIONS**  
FIELD VERIFY ALL EXISTING CONDITIONS. MAKE MINOR ADJUSTMENTS AS NEEDED. INFORM OWNER/ENGINEER OF INCONSISTENCIES IMMEDIATELY IF PROBLEMS OR CONFLICTS EXIST.
6. **COMPLETE AND FUNCTIONAL SYSTEMS**  
PROVIDE ALL LABOR AND MATERIAL FOR A COMPLETE AND FUNCTIONAL SYSTEM. DEMONSTRATE SYSTEM OPERATION TO THE OWNER/ENGINEER.
7. **LABELING**  
THE CONTRACTOR SHALL PROVIDE LAMCOID PRINTED LABELS FOR ALL EQUIPMENT AND TYPED PANELBOARD SCHEDULES AS REQUIRED.
8. **CONTRACTOR MINIMUM REQUIREMENTS**  
PROVIDE AND INSTALL A COMPLETE ELECTRICAL SYSTEM AS INDICATED ON THE DRAWINGS. ITEMS NOT SHOWN BUT OBVIOUSLY NECESSARY FOR A COMPLETE SYSTEM SHALL BE INCLUDED.
- THE CONTRACTOR SHALL OBTAIN ALL NECESSARY PERMITS, INSPECTIONS AND APPROVALS.
- ALL WORK SHALL CONFORM TO THE NATIONAL ELECTRICAL CODE, NFPA, AND THE LOCAL BUILDING CODES. ALL COMPONENTS SHALL BE U.L. APPROVED.
- CONTRACTOR SHALL BE RESPONSIBLE FOR LOCATING ALL CONCEALED FACILITIES BEFORE ANY WORK BEGINS.
9. **SCOPE OF WORK**  
A. COORDINATE NEW ELECTRICAL EQUIPMENT.  
B. DEMO EXISTING EQUIPMENT.  
C. INSTALL NEW EQUIPMENT AND REUSE EXIST. EQUIPMENT.  
D. INSTALL OWNER PURCHASED GENERATOR, LOAD BANK/STARTUP GENERATOR  
E. RESTORE AREAS TO ORIGINAL CONDITION.

10. **CONDUIT**  
CONDUIT SIZES AS SHOWN ON THE DRAWINGS ARE MINIMUM. THE CONTRACTOR MAY INCREASE AS REQUIRED FOR EASE OF PULLING. ALL UNDERGROUND CONDUITS SHALL BE INSTALLED 24" BELOW FINAL GRADE.
11. **JUNCTION BOXES**  
PROVIDE ADDITIONAL BOXES AS MAY BE REQUIRED.
12. **CONDUCTORS**  
SEE THE SPECIFICATIONS.
13. **GROUNDING**  
PROVIDE GROUND SYSTEM AS INDICATED ON THE DRAWINGS AND AS REQUIRED BY THE NATIONAL ELECTRIC CODE.
14. **FUTURES FACILITIES**  
WHERE FUTURE FACILITIES ARE INDICATED. CONDUIT ROUTING SHALL ACCOUNT FOR SUCH FACILITIES.
15. **RESPONSIBILITIES**  
BIDDERS, SUPPLIERS, EQUIPMENT VENDORS, GENERAL CONTRACTOR, SUB CONTRACTORS AND OTHER SIMILAR ENTITIES ARE REQUIRED TO READ ALL THE CONTRACT DOCUMENTS INCLUDING DRAWINGS AND SPECIFICATIONS.
16. **HOME RUNS**  
CONTRACTOR SHALL COORDINATE HOME RUNS BETWEEN PLAN VIEWS. WHERE ANY CONDUIT IS SHOWN IN ANY PLAN VIEW IT SHALL BE INSTALLED THE ENTIRE LENGTH AS MAY BE REQUIRED.
17. **SEPARATION**  
MAINTAIN MIN. 12" SEPARATION BETWEEN 4-20MADC SIGNAL AND OTHER RACEWAYS.
18. **RESTORATION**  
CONTRACTOR SHALL RESTORE TO ORIGINAL CONDITION ALL FACILITIES HE DISTURBS. CONTRACTOR SHALL PROVIDE CLEANUP, AND PROPER DISPOSAL, AND PAY ALL FEES FOR ALL DEMOLISHED MATERIALS AND THE LIKE.
19. **WARRANTY**  
CONTRACTOR SHALL WARRANT LABOR AND MATERIALS FOR A PERIOD OF ONE (1) YEAR FROM THE OWNER'S ACCEPTANCE OF THE COMPLETED PROJECT.
20. **LRO REQUIREMENTS**  
PROVIDE MATERIALS AND METHODS PER LOXAHATCHEE RIVER DISTRICT REQUIREMENTS AND THESE DRAWINGS AND SPECIFICATIONS.
- LRO IS PROVIDING BYPASS PUMPING EQUIPMENT, CONTRACTOR SHALL COORDINATE ALL WORK WITH LRO.

ELECTRICAL ABBREVIATIONS

CP	CONTROL PANEL	OH	OVERHEAD
CM	COMPRESSOR	OOX	OFF, OFF, ON
CR	CONTROL RELAY	PB	PUSH BUTTON
CP	CONTROL PANEL	PB	PULL BOX
DISC	DISCONNECT SWITCH	PDP	POWER DIST. PANEL
ETM	ELAPSED TIME METER	PM	POWER MONITOR
F	FUSE	PSCP	PUMP STATION CONTROL PANEL
FSA	FIELD SURGE ARRESTOR	R,G,A	RED, GREEN, AMBER PILOT LIGHT
GEN	GENERATOR	RTU	REMOTE TERMINAL UNIT
GFI	GROUND FAULT INTERRUPTER	SM	SUB-METER
HLA	HIGH LEVEL ALARM	SA	SURGE ARRESTER
HOA	HAND-OFF-AUTO	SB	SURGE BOX
HOR	HAND-OFF-REMOTE	SC	SURGE CAPACITOR
IPB	INST. PULL BOX	SCC	SHIELDED CONTROL CABLE
JP	JOCKEY PUMP	SS	SELECTOR SWITCH OR 316 STAINLESS STEEL
LA	LIGHTNING ARRESTER	TB	TERM. BOX
LLA	LOW LEVEL ALARM	TD	TIME DELAY
LSCP	LIFT STATION CONTROL PANEL	TS	TEST SWITCH
LRD	LOXAHATCHEE RIVER DISTRICT	WP	WEATHER PROOF
M	MOTOR STARTER	XFMR	TRANSFORMER
MCC	MOTOR CONTROL CENTER	ZSC	POSITION SWITCH CLOSED
MLO	MAIN LUGS ONLY	ZSO	POSTION SWITCH OPEN
MP	MAIN PUMP		
OL	OVER LOAD RELAY		


CONDUIT LEGEND

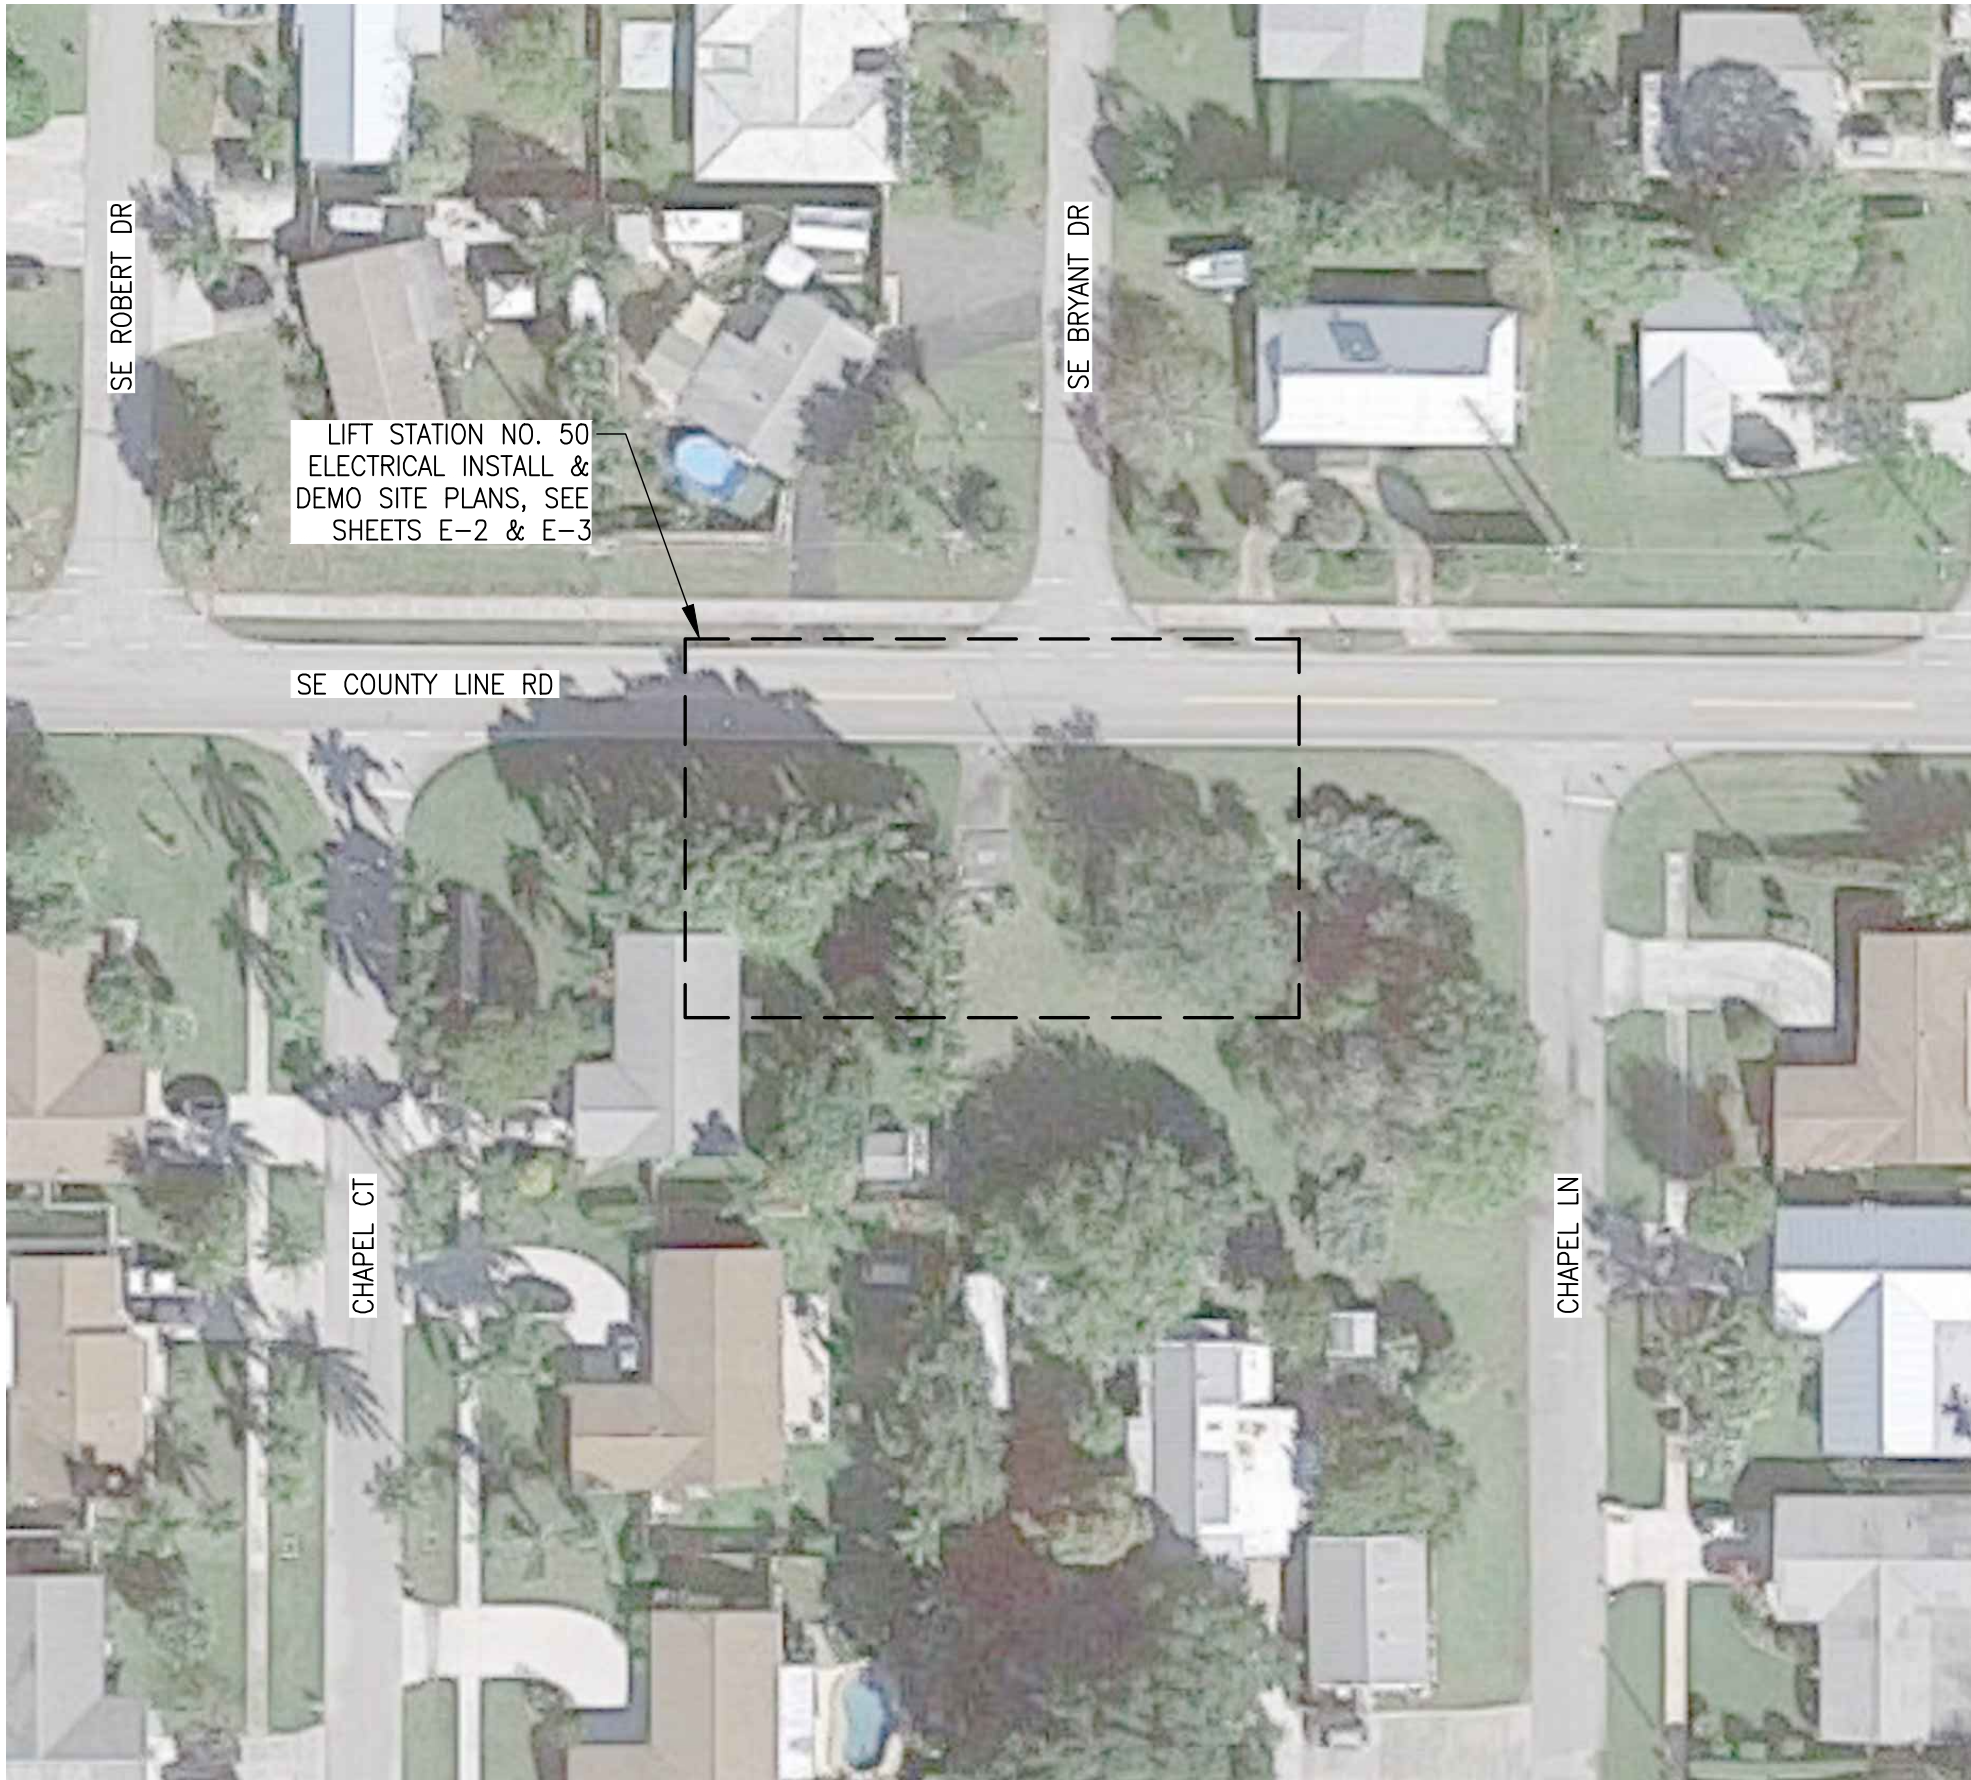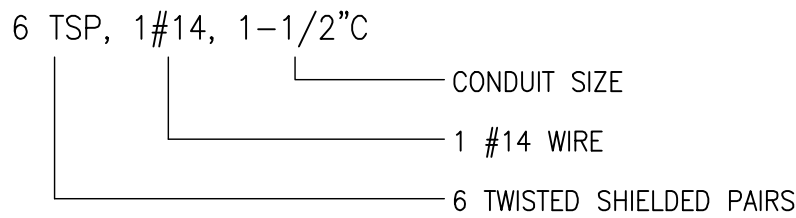

LIFT STATION NO. 50 AERIAL SITE PLAN

NTS

ELECTRICAL LEGEND

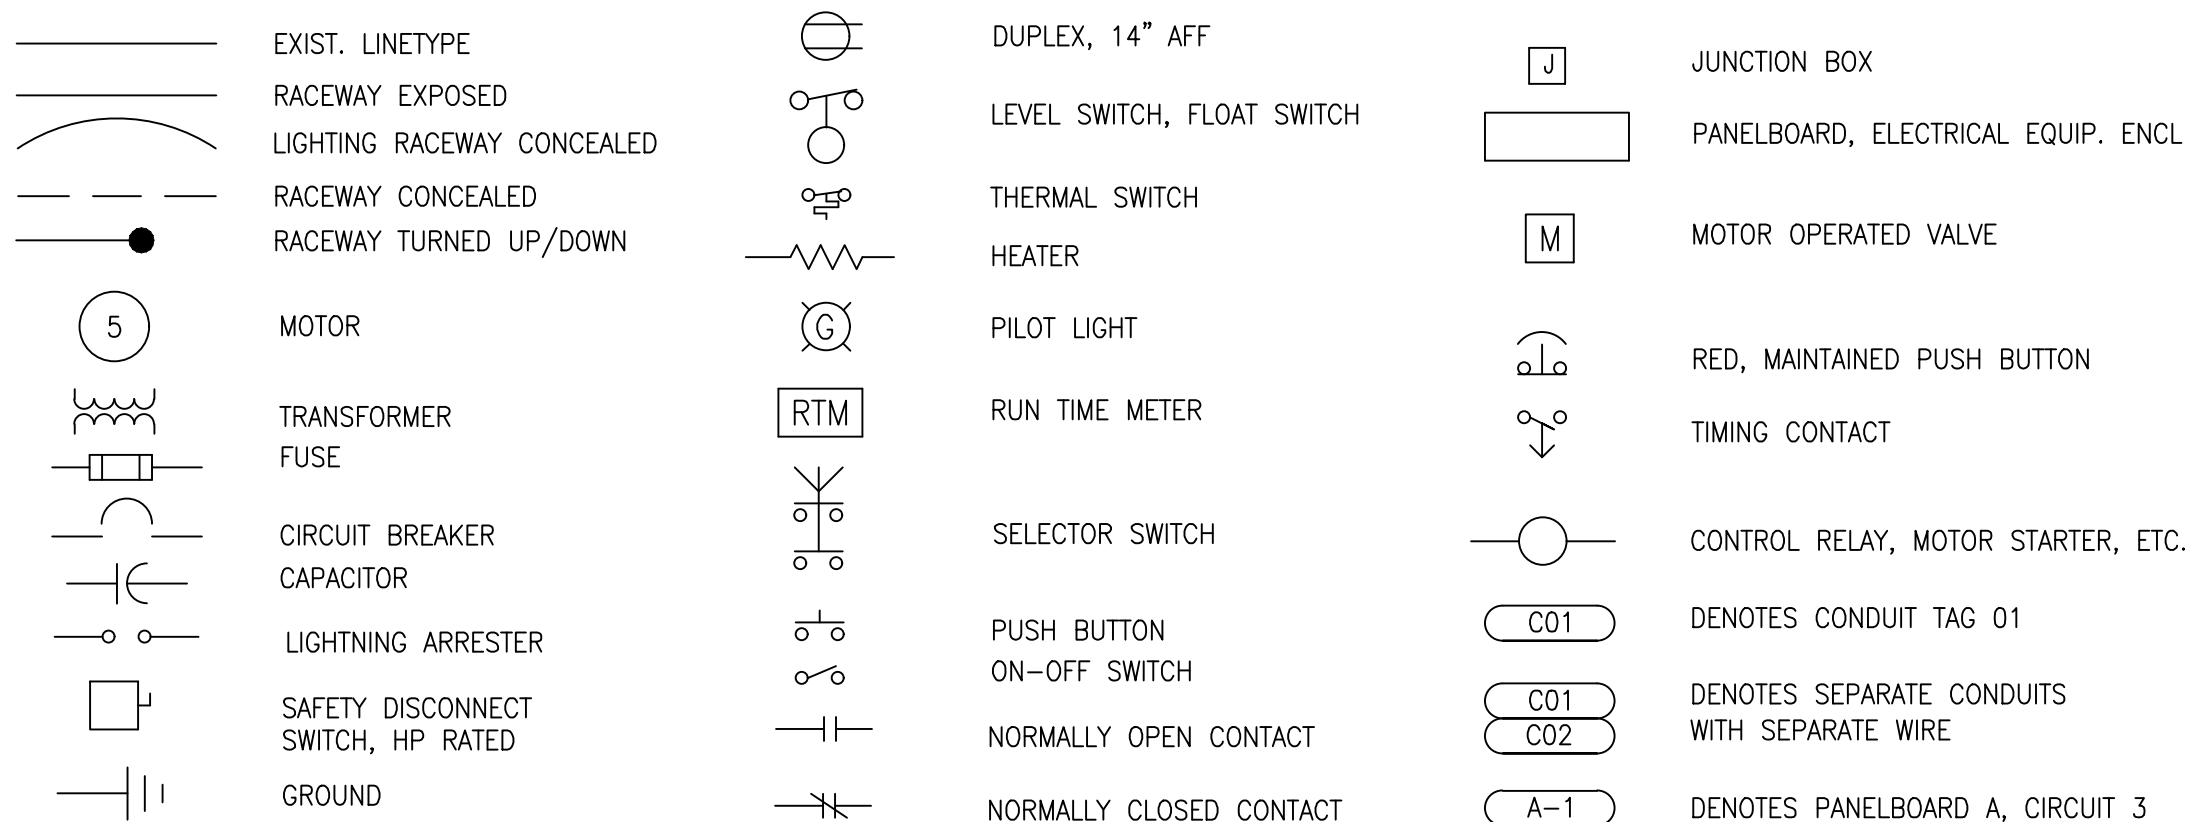

MATERIAL SCHEDULE

LOCATION	CONDUIT	ENCLOSURE MATERIALS	ENCLOSURE NEMA RATING	FASTENERS, STRUT, THREADED ROD, ETC.	REMARKS
EXTERIOR					
BELOW GRADE	PVC SCHED. 40	CONCRETE BOXES	N/A	316 SS	
ABOVE GRADE	PVC SCHED. 80	316 SS	4X	316 SS	
ABOVE GRADE (CP & TERM. JBOX) *	RGS & E/P SEAL OFF	316 SS	4X	316 SS	EYS E/P CONDUIT SEALS

\* PROVIDE DUCT SEAL PUTTY AT ALL CONDUIT PENETRATIONS TO CONTROL PANEL AND RTU ENCL, ALSO TO CONDUITS ENTERING TERMINAL JBOX FROM WETWELL & VALVE VAULT EYS EXPLOSION PROOF RGS FITTING OR SEALING HUB WITH CHICO A/X FOR CONDUIT EXP. FITTING BETWEEN TERM. JBOX AND CONTROL PANEL.

GENERAL NOTES

1. THE SCHEDULE SHALL ESTABLISH THE MINIMUM LEVEL OF QUALITY FOR MATERIALS. UNLESS OTHERWISE INDICATED ON THE DRAWINGS OR IN THE SPECIFICATIONS
2. THE SCHEDULE SHALL NOT APPLY TO POWER TRANSFORMERS, LIGHT FIXTURES AND THE LIKE, THOSE ELEMENTS MAY BE NOTED OR INDICATED ELSEWHERE

LEGEND

N/A	NOT APPLICABLE
316 SS	316 STAINLESS STEEL
E/P	EXPLOSION PROOF

REV	DATE	REVISIONS	BY

VERIFY SCALE  
BAR IS EQUAL TO ONE  
INCH ON ORIGINAL DRAWING  
0 1  
ADJUST ALL SCALED  
DIMENSIONS ACCORDINGLY

Date: 03/25/24  
Scale: AS NOTED  
Design By: JLR  
Drawn By: AOD  
Check By: MAG

LOXAHATCHEE RIVER DISTRICT  
LIFT STATION NO. 50  
EMERGENCY GENERATOR PROJECT

ELECTRICAL NOTES & LEGEND

HOLTZ CONSULTING ENGINEERS, INC.




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JUPITER, FLORIDA 33458  
PH. (561) 575-2005  
Cert. No. 26960

MICHAEL A. GUIDA, P.E.

License No: 60755

E-1

**C&W engineering**  
ELECTRICAL CONSULTANTS  
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WEST PALM BEACH, FL. 33411  
(561) 642-5333  
**REGISTRATION NUMBERS**  
C & W ENGINEERING INC. CA# 33315  
MICHAEL A. GUIDA, P.E. 60755

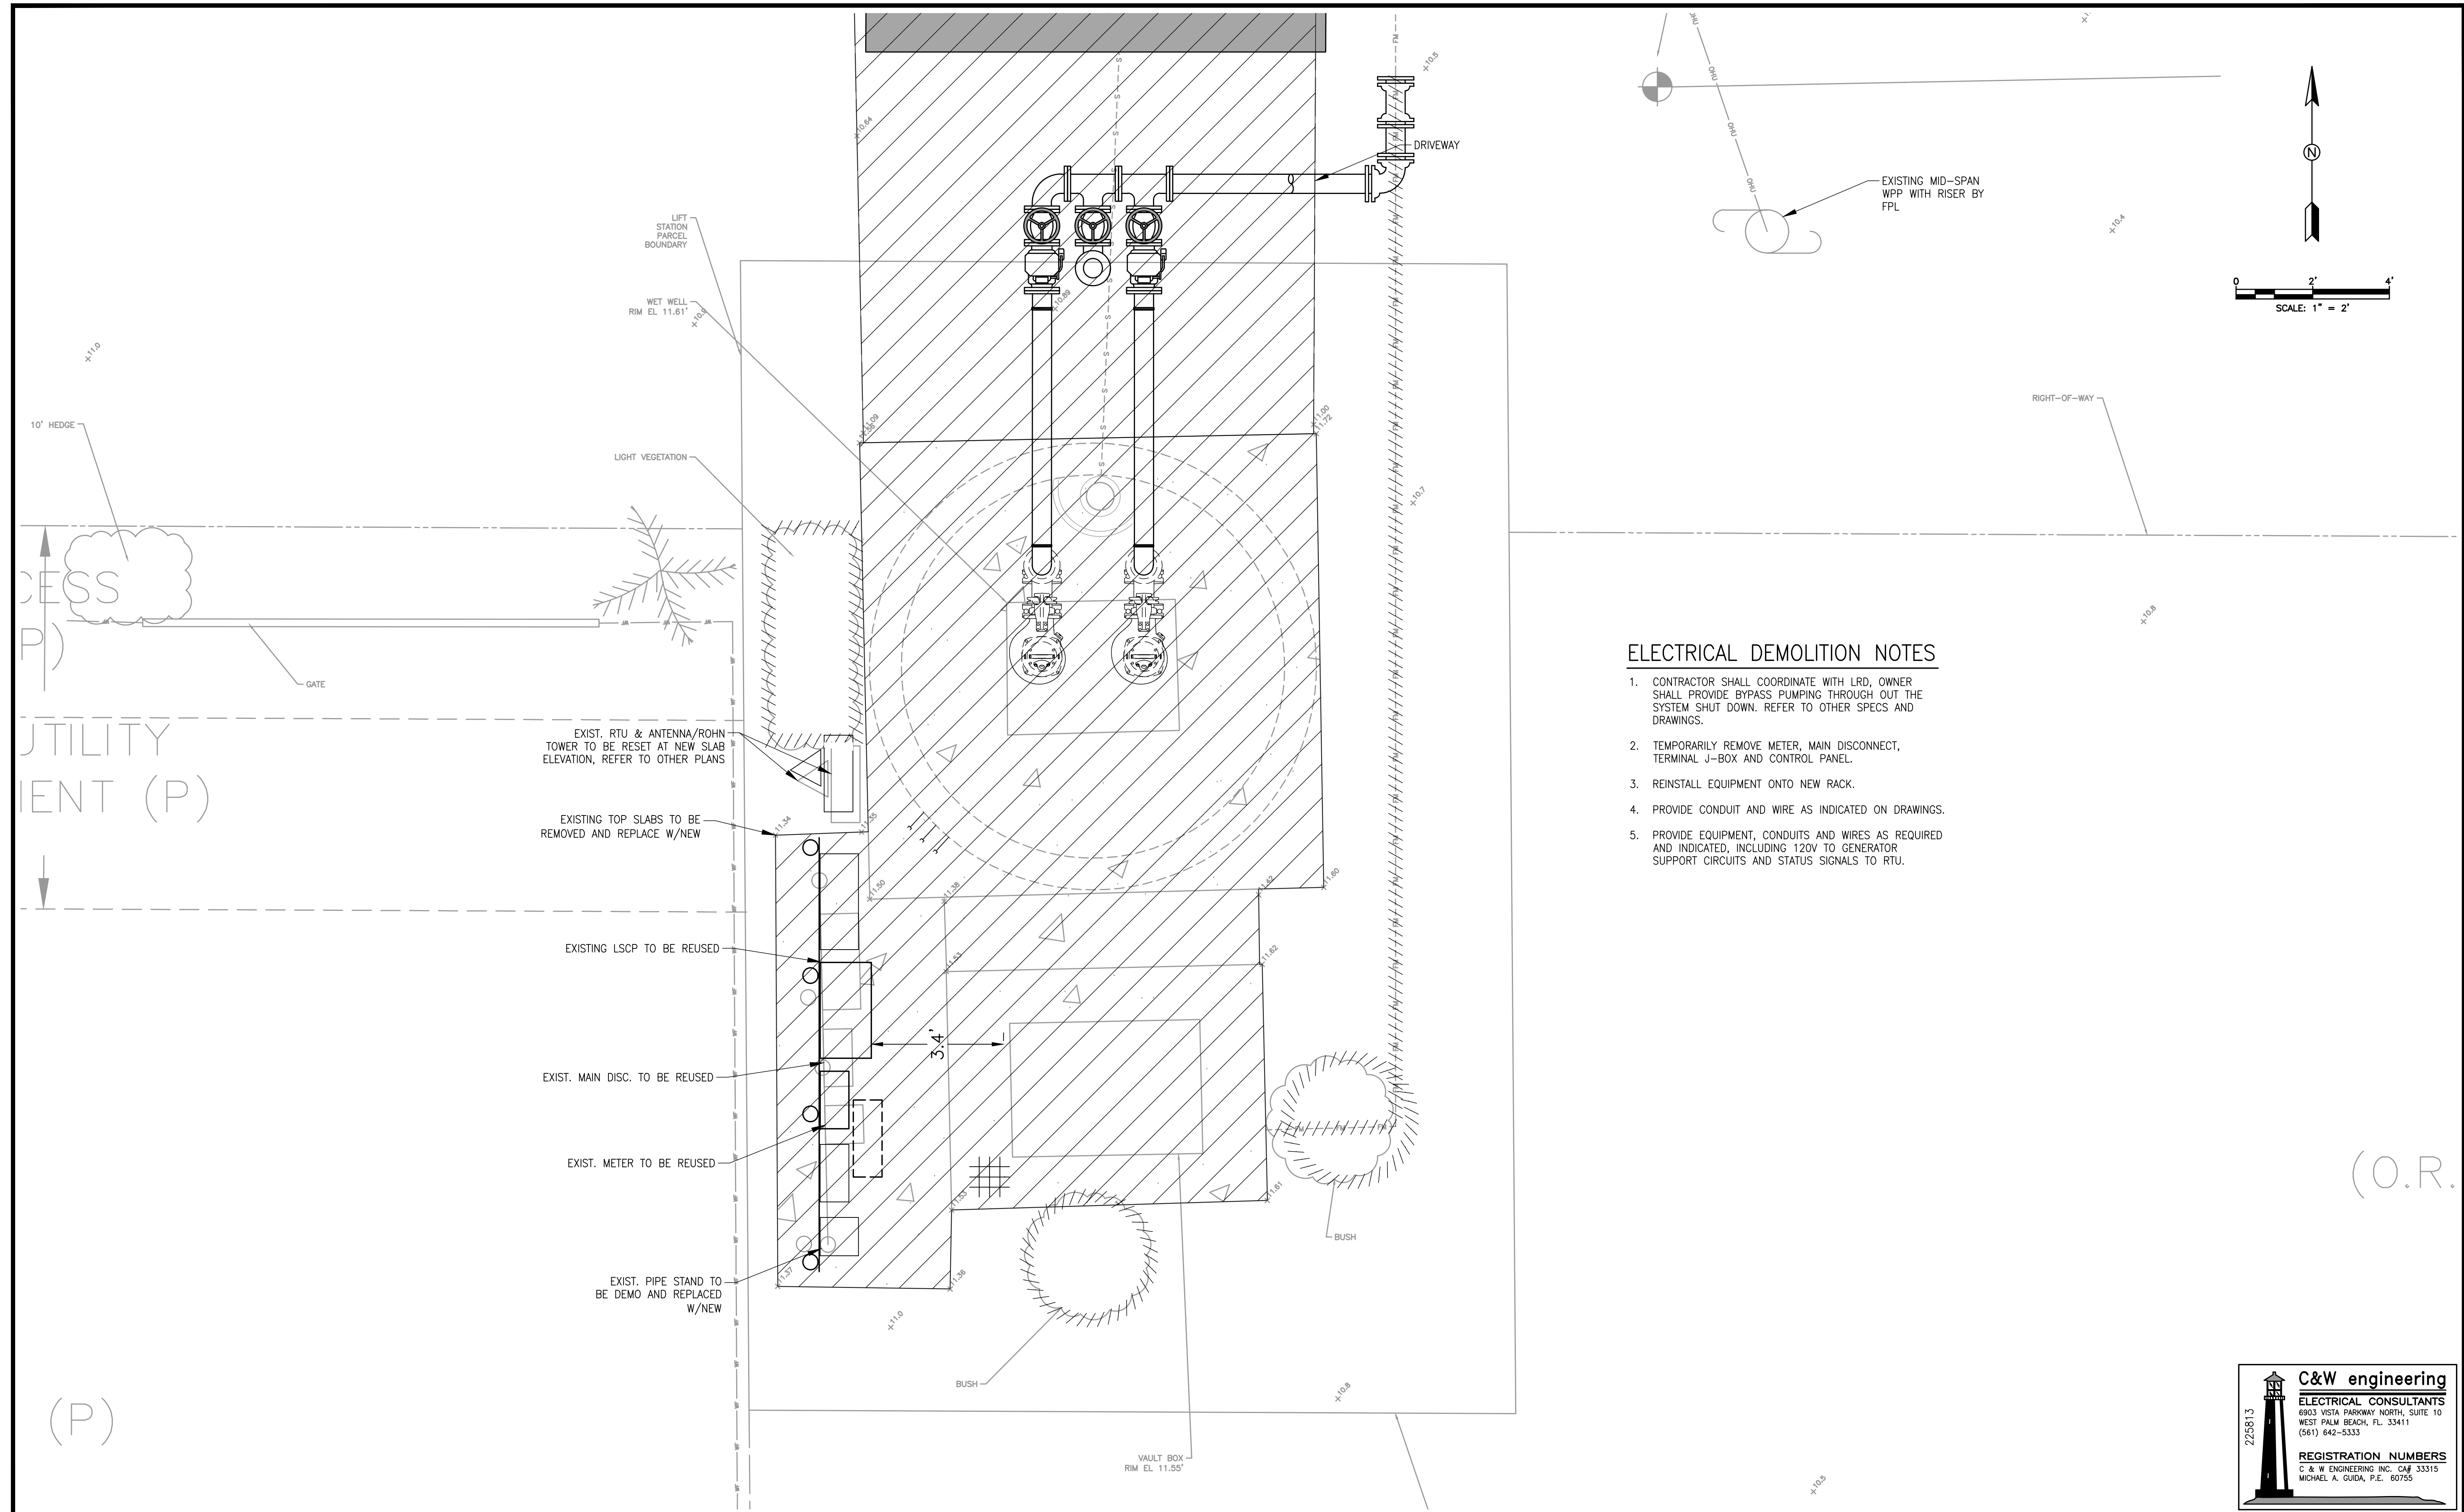

ELECTRICAL DEMOLITION NOTES

1. CONTRACTOR SHALL COORDINATE WITH LRD, OWNER SHALL PROVIDE BYPASS PUMPING THROUGH OUT THE SYSTEM SHUT DOWN. REFER TO OTHER SPECS AND DRAWINGS.
2. TEMPORARILY REMOVE METER, MAIN DISCONNECT, TERMINAL J-BOX AND CONTROL PANEL.
3. REINSTALL EQUIPMENT ONTO NEW RACK.
4. PROVIDE CONDUIT AND WIRE AS INDICATED ON DRAWINGS.
5. PROVIDE EQUIPMENT, CONDUITS AND WIRES AS REQUIRED AND INDICATED, INCLUDING 120V TO GENERATOR SUPPORT CIRCUITS AND STATUS SIGNALS TO RTU.

REV	DATE	REVISIONS	BY

VERIFY SCALE  
BAR IS EQUAL TO ONE  
INCH ON ORIGINAL DRAWING  
0 1  
ADJUST ALL SCALED  
DIMENSIONS ACCORDINGLY

Date: 03/25/24  
Scale: AS NOTED  
Design By: JLR  
Drawn By: AOD  
Check By: MAG

LOXAHATCHEE RIVER DISTRICT  
LIFT STATION NO. 50  
EMERGENCY GENERATOR PROJECT

ELECTRICAL DEMOLITION SITE PLAN

HOLTZ CONSULTING ENGINEERS, INC.  
**HCE** 270 SOUTH CENTRAL BLVD., SUITE 207  
JUPITER, FLORIDA 33458  
PH. (561) 575-2005  
Cert. No. 26960

MICHAEL A. GUIDA, P.E.  
License No: 60755

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225813

**C&W engineering**  
ELECTRICAL CONSULTANTS  
6903 VISTA PARKWAY NORTH, SUITE 10  
WEST PALM BEACH, FL. 33411  
(561) 642-5333  
**REGISTRATION NUMBERS**  
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SPECIFIC ELECTRICAL NOTES

- 1 THE CONTRACTOR SHALL INSTALL OWNER FURNISHED GENERATOR W/OPTIONS BOARD AND DISCRETE WIRES AS REQUIRED TO MEET I/O. CONTRACTOR SHALL BE RESPONSIBLE FOR COORDINATION WITH GENERATOR MANUFACTURER FOR START UP.
- 2 PROVIDE 1#4 CU, BOND TO GROUND ELECTRODE 5/8"x20'.
- 3 CONTRACTOR SHALL PROVIDE I/O SIGNALS TO EXISTING RTU. RTU MODIFICATIONS AND PROGRAMING TO INCORPORATE GENERATOR AND ATS SIGNALS INTO EXISTING DFS TELEMETRY. ALL WORK ASSOCIATED WITH THE RTU IS TO BE PERFORMED BY: DATA FLOW SYSTEMS, INC. OF MELBOURNE, FL.

RTU HARDWIRED SIGNALS

ATSD: ATS ON COMMERCIAL POWER  
ATS ON GENERATOR POWER

GEND: GENERATOR FAIL TO START  
GENERATOR GENERAL ALARM  
GENERATOR LOW FUEL  
GENERATOR LOW COOLANT

SEE SIGNALS ON E-5

PANELBOARD A SCHEDULE



COND SIZE	WIRE SIZE	BUS AMPS		LOAD	POLES	AMPS	BUS A B		AMPS	POLES	LOAD	BUS AMPS A B		WIRE SIZE	COND SIZE
		A	B				A	B				A	B		
							1	2	20	1	GENSET BATT. CHGR	5		3#12	3/4
							3	4	20	1	JACKET HEATER		7	3#12	3/4
							5	6	20	1	SPARE				
				SPARE		1	20		20	1	SPARE				

RATED VOLTAGE: <input checked="" type="checkbox"/> 120/240 <input type="checkbox"/> 277/480	1ø, 3 WIRE	BRANCH POLES: <input checked="" type="checkbox"/> 8 <input type="checkbox"/> 12	APPROVED MF'RS. CUTLER HAMMER, SQD ONLY
RATED AMPS: <input checked="" type="checkbox"/> 100 <input type="checkbox"/> 225 <input type="checkbox"/> 400 <input type="checkbox"/> _____		CABINET: <input checked="" type="checkbox"/> SURFACE <input type="checkbox"/> FLUSH	NEMA <input type="checkbox"/> 1 <input checked="" type="checkbox"/> 3R <input type="checkbox"/> 4X
<input type="checkbox"/> MAIN LUGS ONLY <input type="checkbox"/> MAIN 60 AMPS <input checked="" type="checkbox"/> BREAKER <input type="checkbox"/> FUSED SWITCH		<input checked="" type="checkbox"/> HINGED DOOR	<input checked="" type="checkbox"/> KEYED DOOR LATCH
<input type="checkbox"/> FUSED <input checked="" type="checkbox"/> CIRCUIT BREAKER (BOLT-IN) BRANCH DEVICES		<input type="checkbox"/> _____ TO BE GFI BREAKERS	FULL NEUTRAL BUS GROUND BUS
ALL BREAKERS MUST BE RATED TO INTERRUPT A SHORT CIRCUIT ISC OF 22,000 AMPS SYMMETRICAL.			

240V 3Ø LOAD CALCULATION

DESCRIPTION	AMPS
PUMP 1 (15HP) x 125%	52.5
PUMP 2 (15HP)	42
CONTROLS & GEN.	9
TOTAL	103.5
EXISTING 240V, 3Ø SERVICE	150A

EXIST. 240V SERVICE IS LESS THAN 2% VOLTAGE DROP

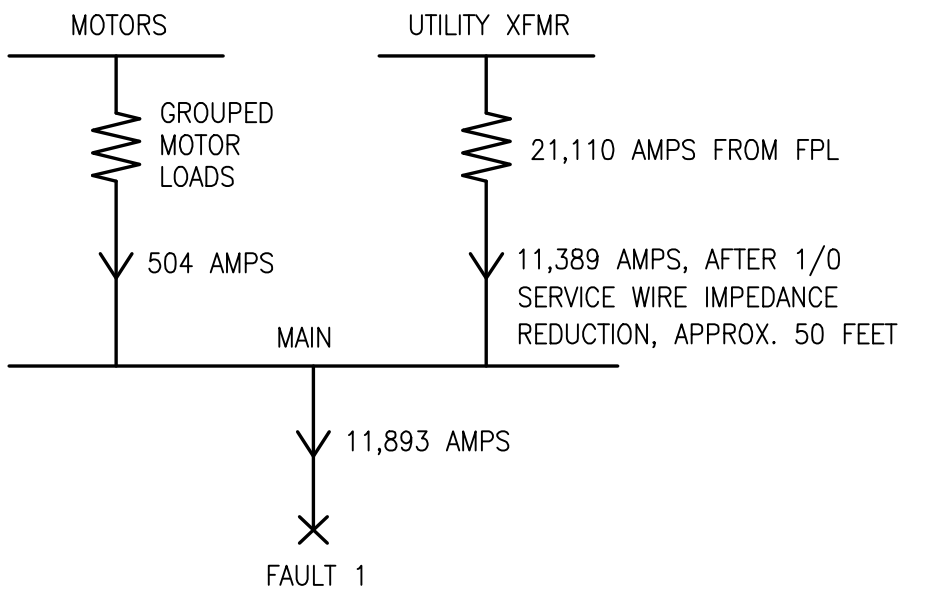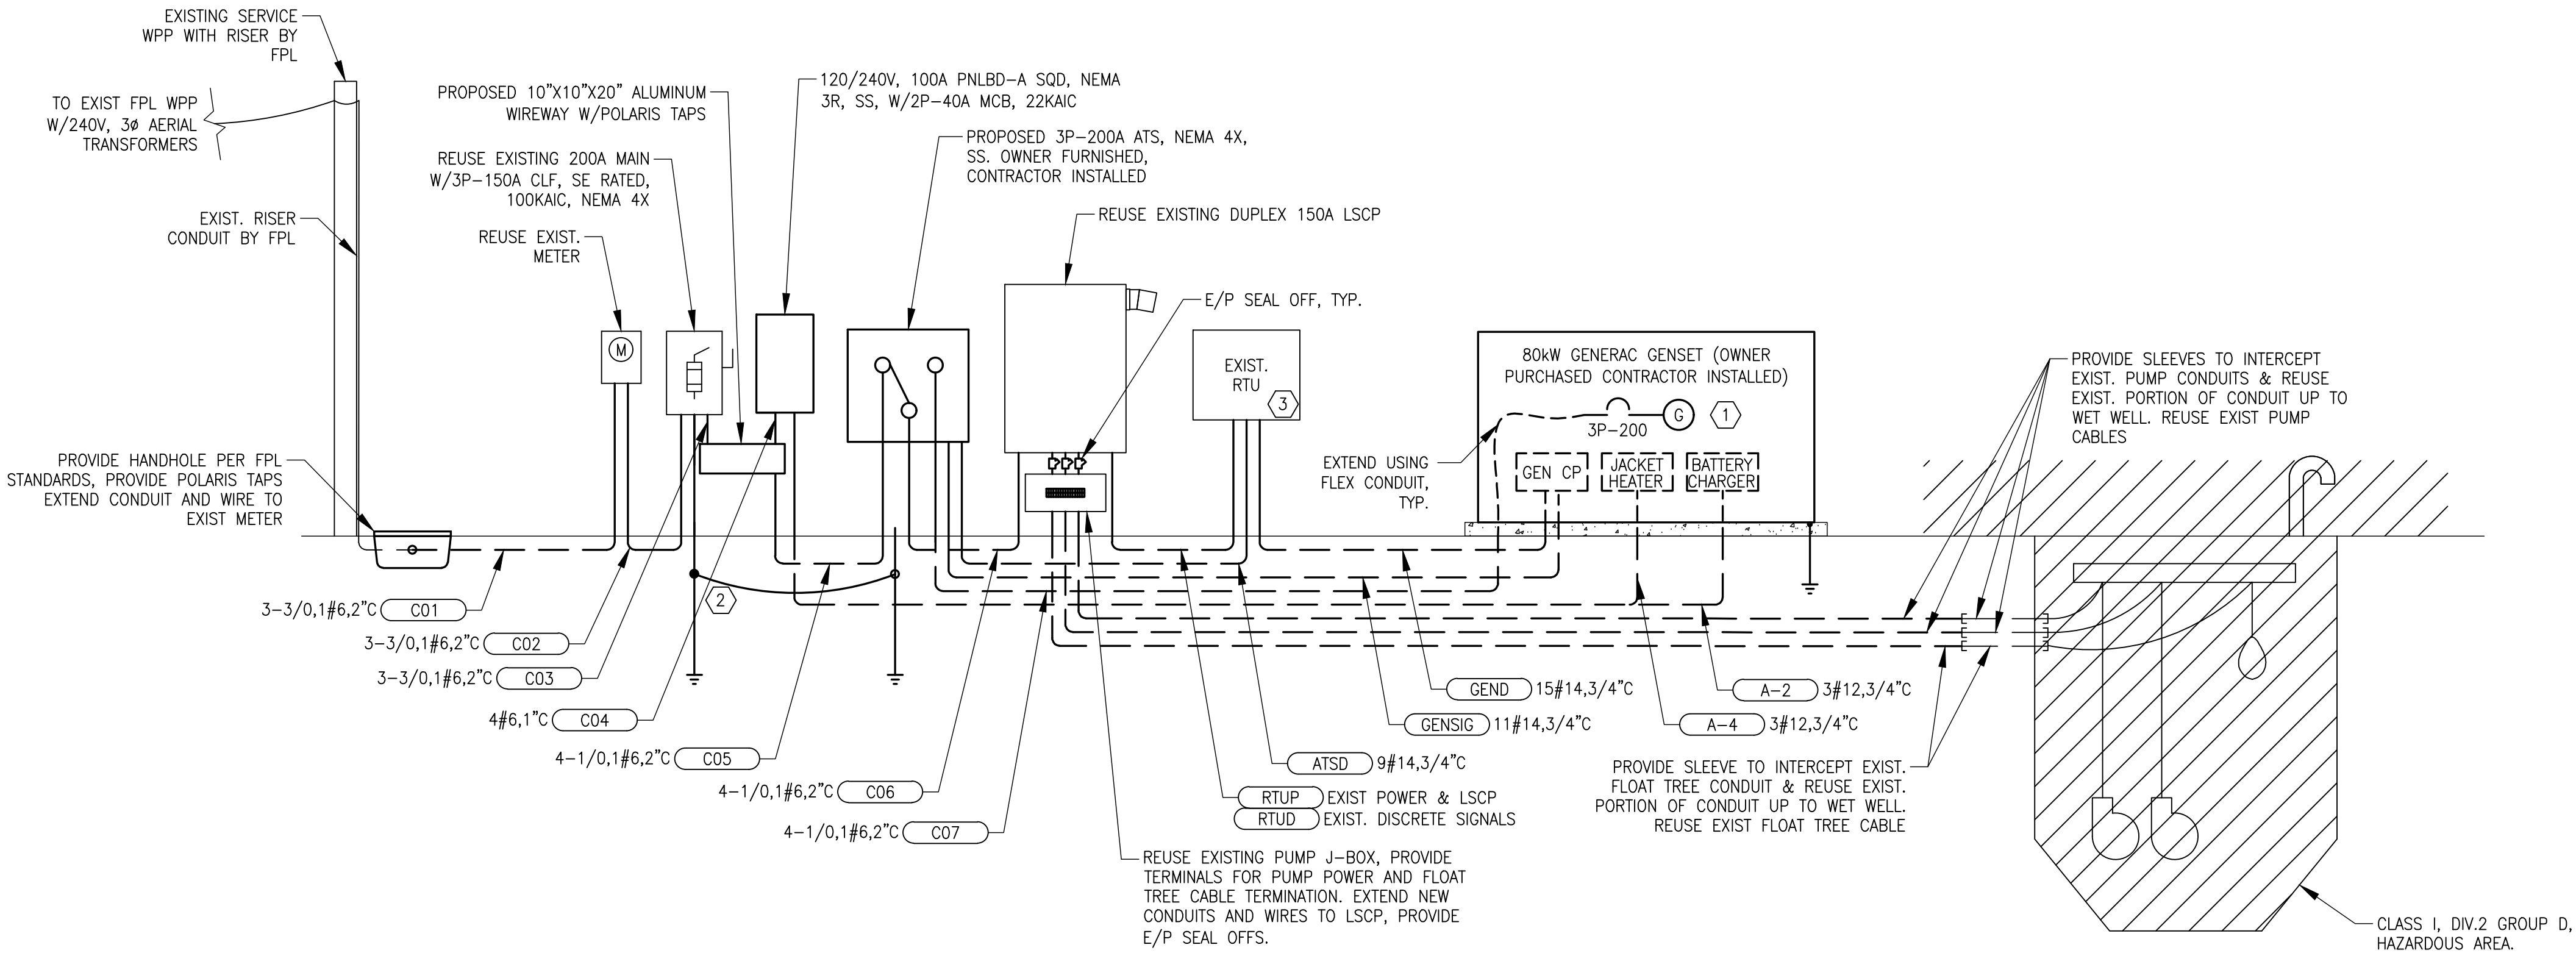

FAULT 1 = GROUPED MOTOR + UTILITY

GROUPED MOTOR LOADS = (2 @ 15HP) X 6.0

= (2 X 42A) X 6.0

= 504 AMPS OF MOTOR CONTRIBUTION

UTILITY = 11,389 AMPS

FAULT = 11,389 AMPS + 504 AMPS = 11,893 AMPS

FAULT CURRENT CALCULATION

LS NO. 50 240V 3Ø ELECTRICAL RISER DIAGRAM, CLASS 1, DIV. 2, GROUP D HAZARDOUS AREA

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LOXAHATCHEE RIVER DISTRICT  
LIFT STATION NO. 50  
EMERGENCY GENERATOR PROJECT


ELECTRICAL RISER DIAGRAM


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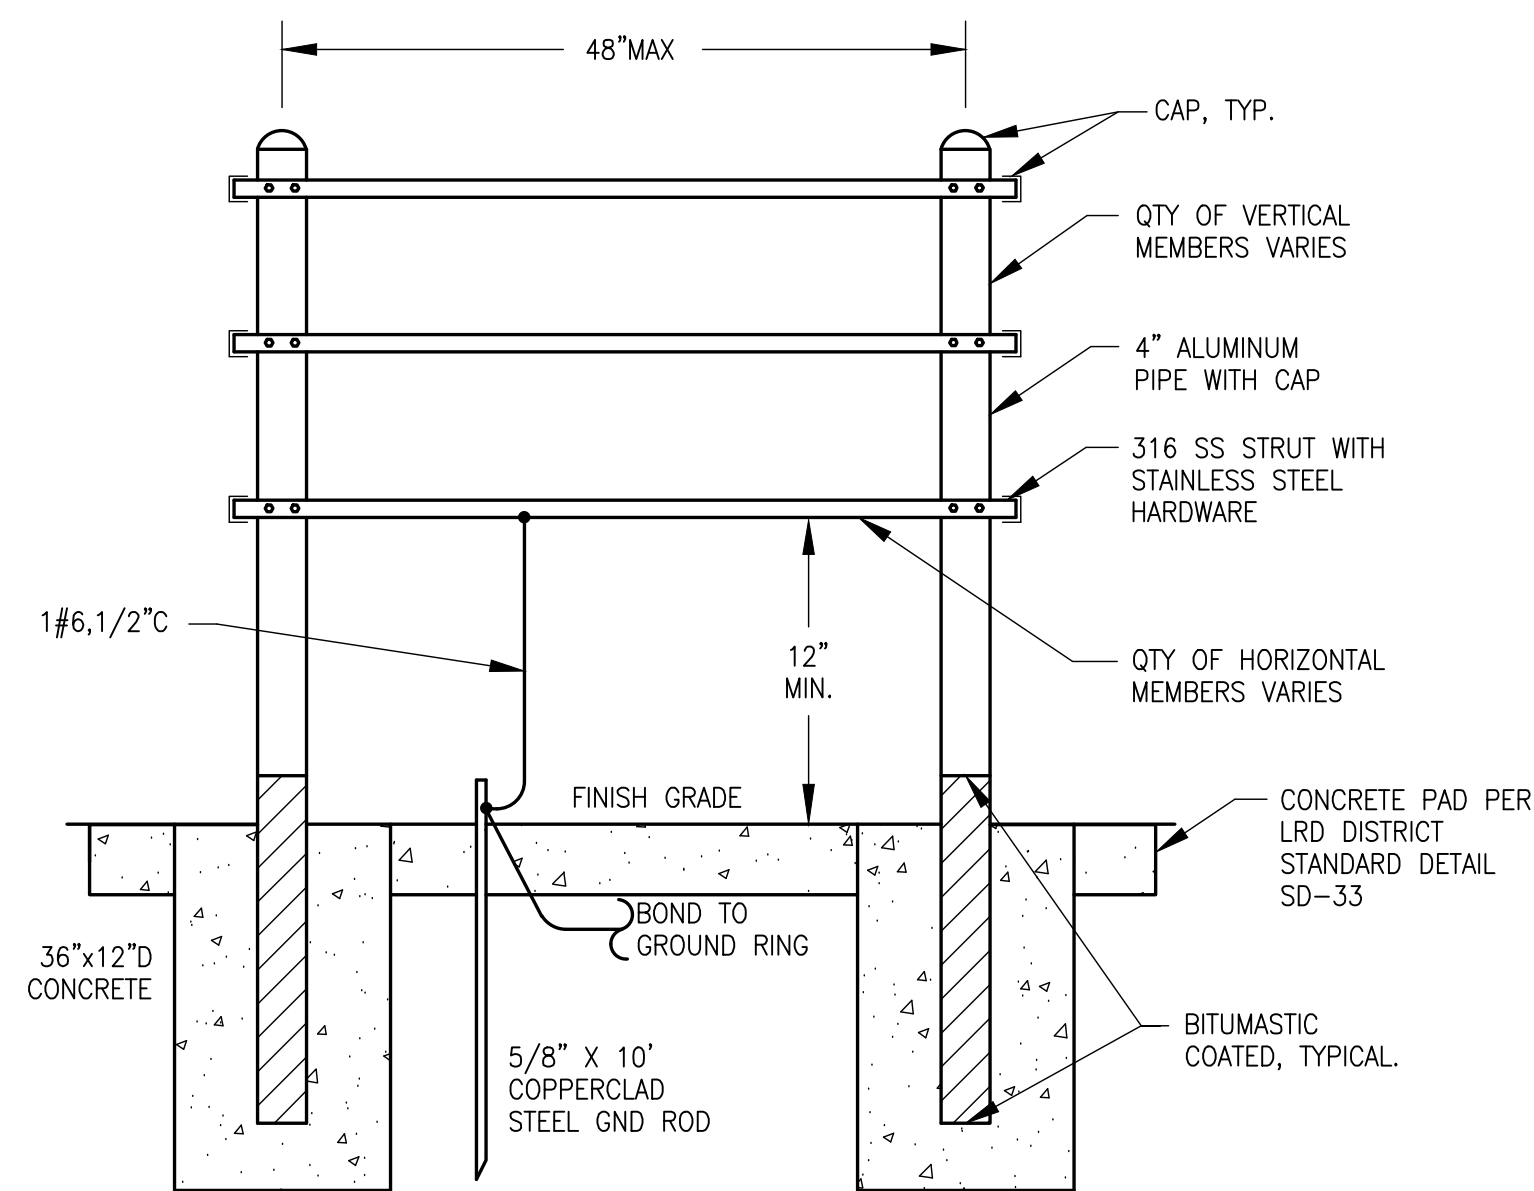
License No: 60755

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NOTE: CONTRACTOR SHALL BUILD PIPE STAND SIMILAR TO LAYOUT SHOWN IN LRD STANDARD DETAIL SD-33. MATERIALS CALLED IN DETAIL BELOW SHALL BE ENFORCED




PIPE STAND, CONCRETE MOUNT

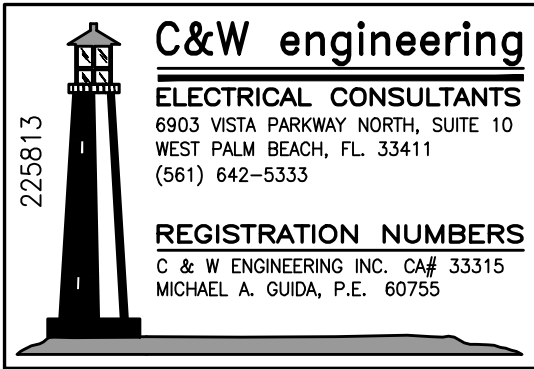NTS, FOR ATS/PNL

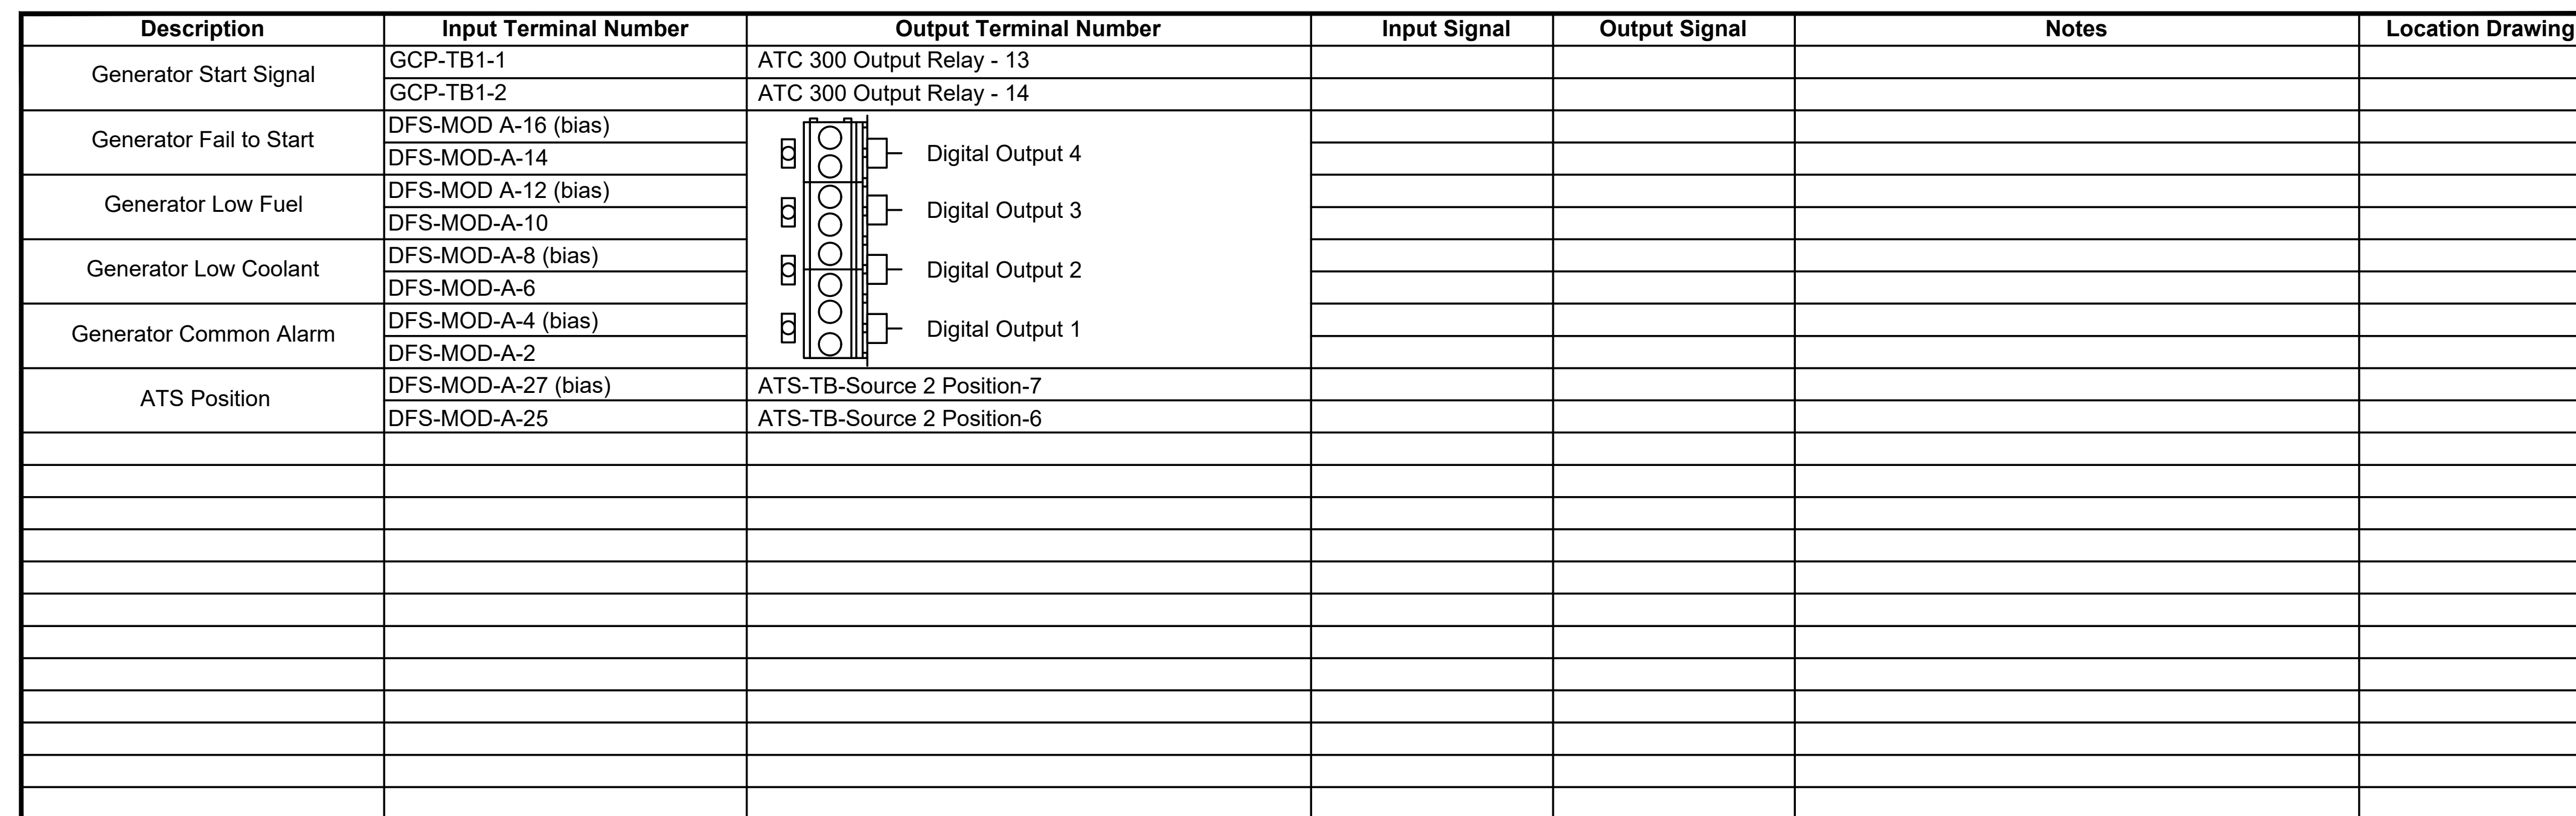
A

NOTE: CONTRACTOR SHALL MOUNT EXIST. LIFT STATION CONTROL PANEL & J-BOX SIMILAR TO LRD STANDARD DETAIL SD-33. NOT ALL PROPOSED AND EXISTING EQUIPMENT ARE SHOWN IN DETAIL BELOW, REFER TO OTHER PLANS.

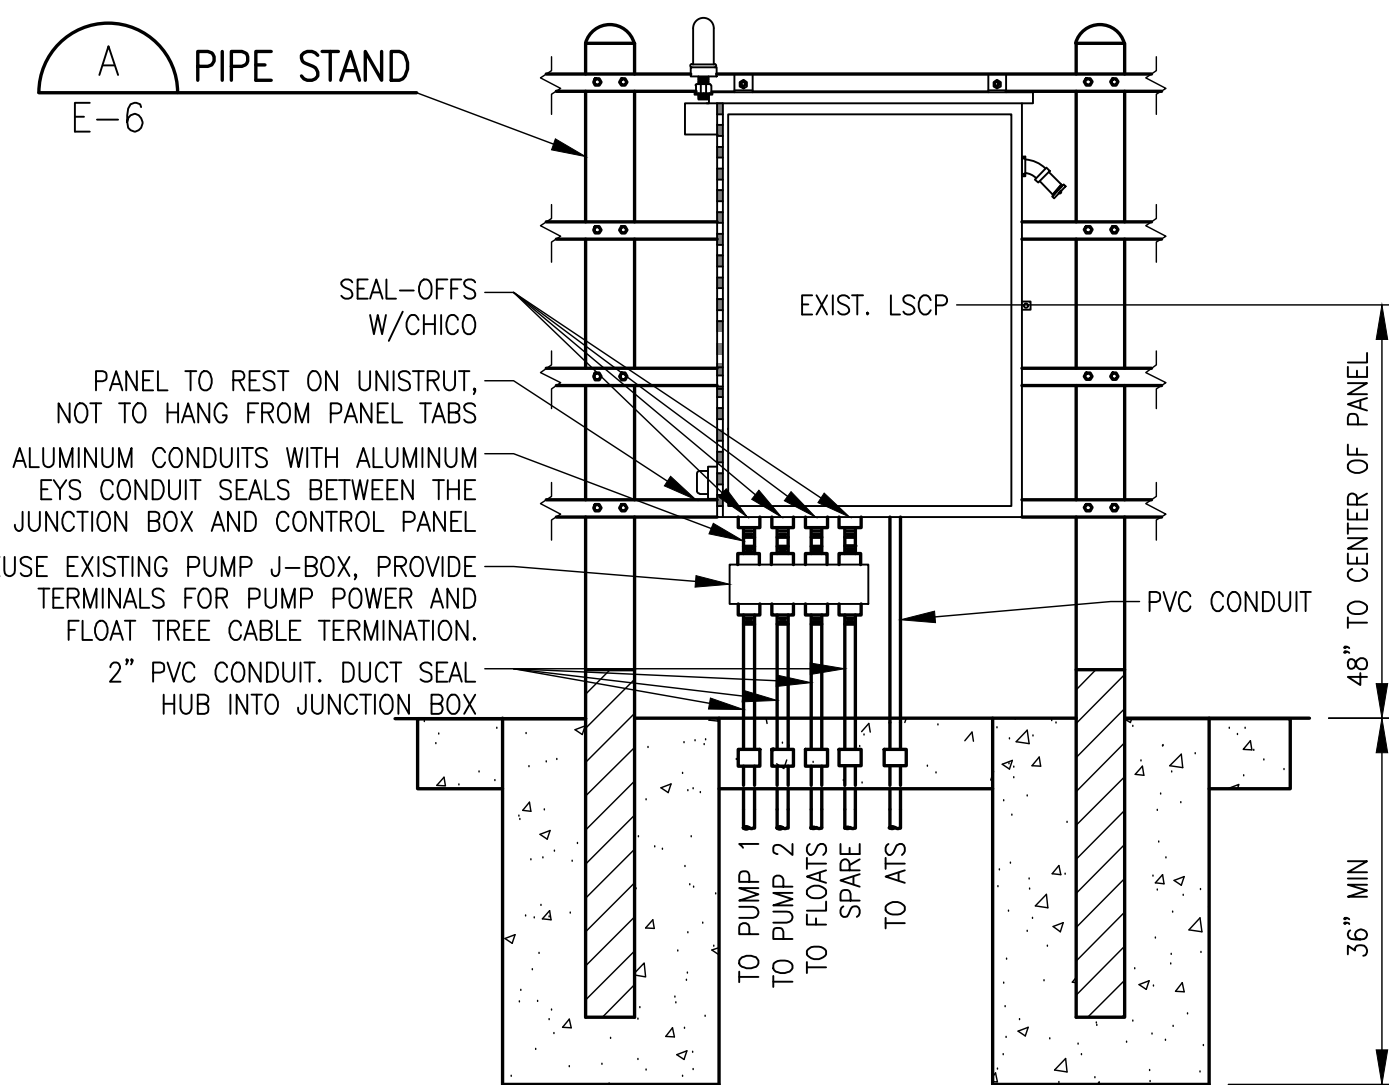

LIFT STATION CONTROL PANEL MOUNTING DETAIL


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GROUND WELL DETAIL

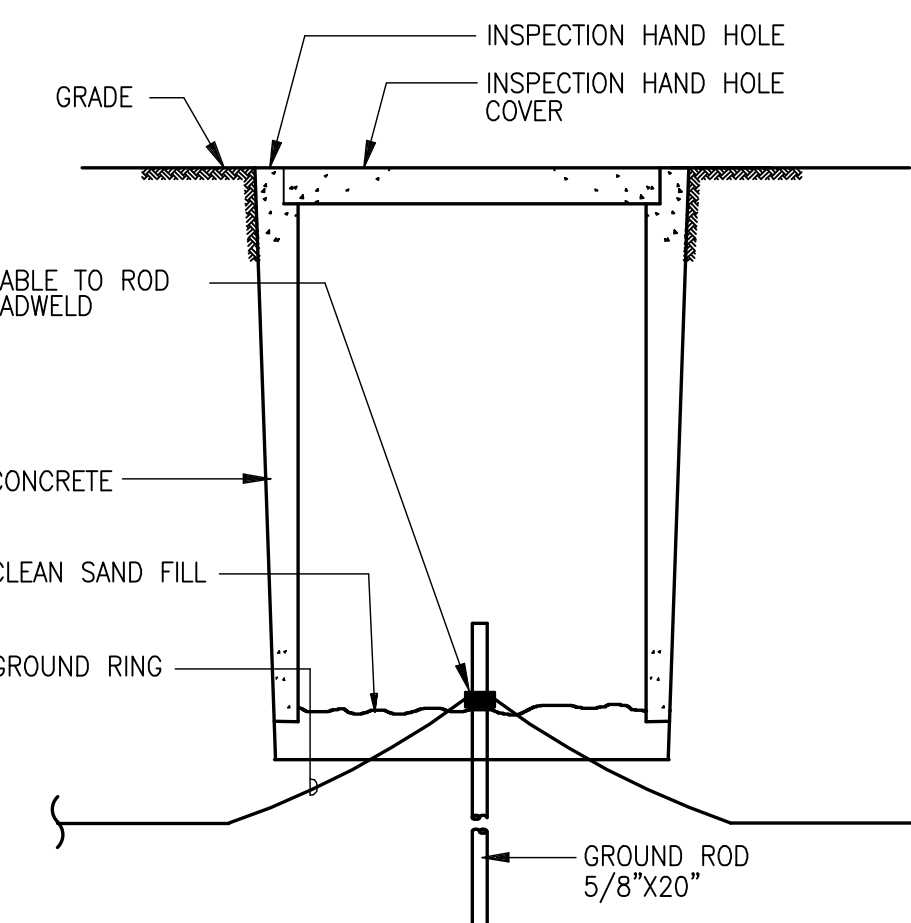
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B




DIRECT BURIED CONDUIT

NTS

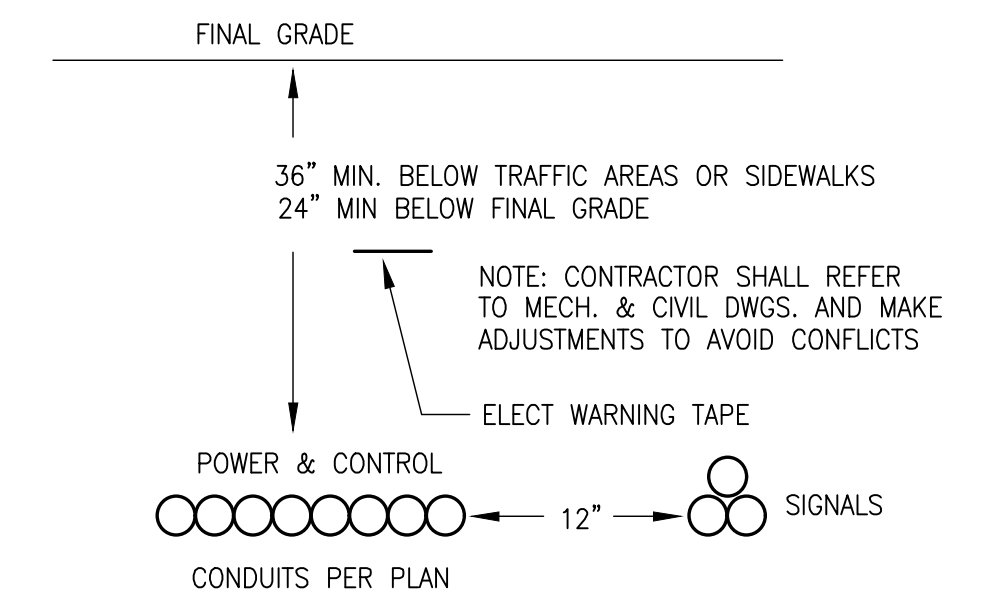

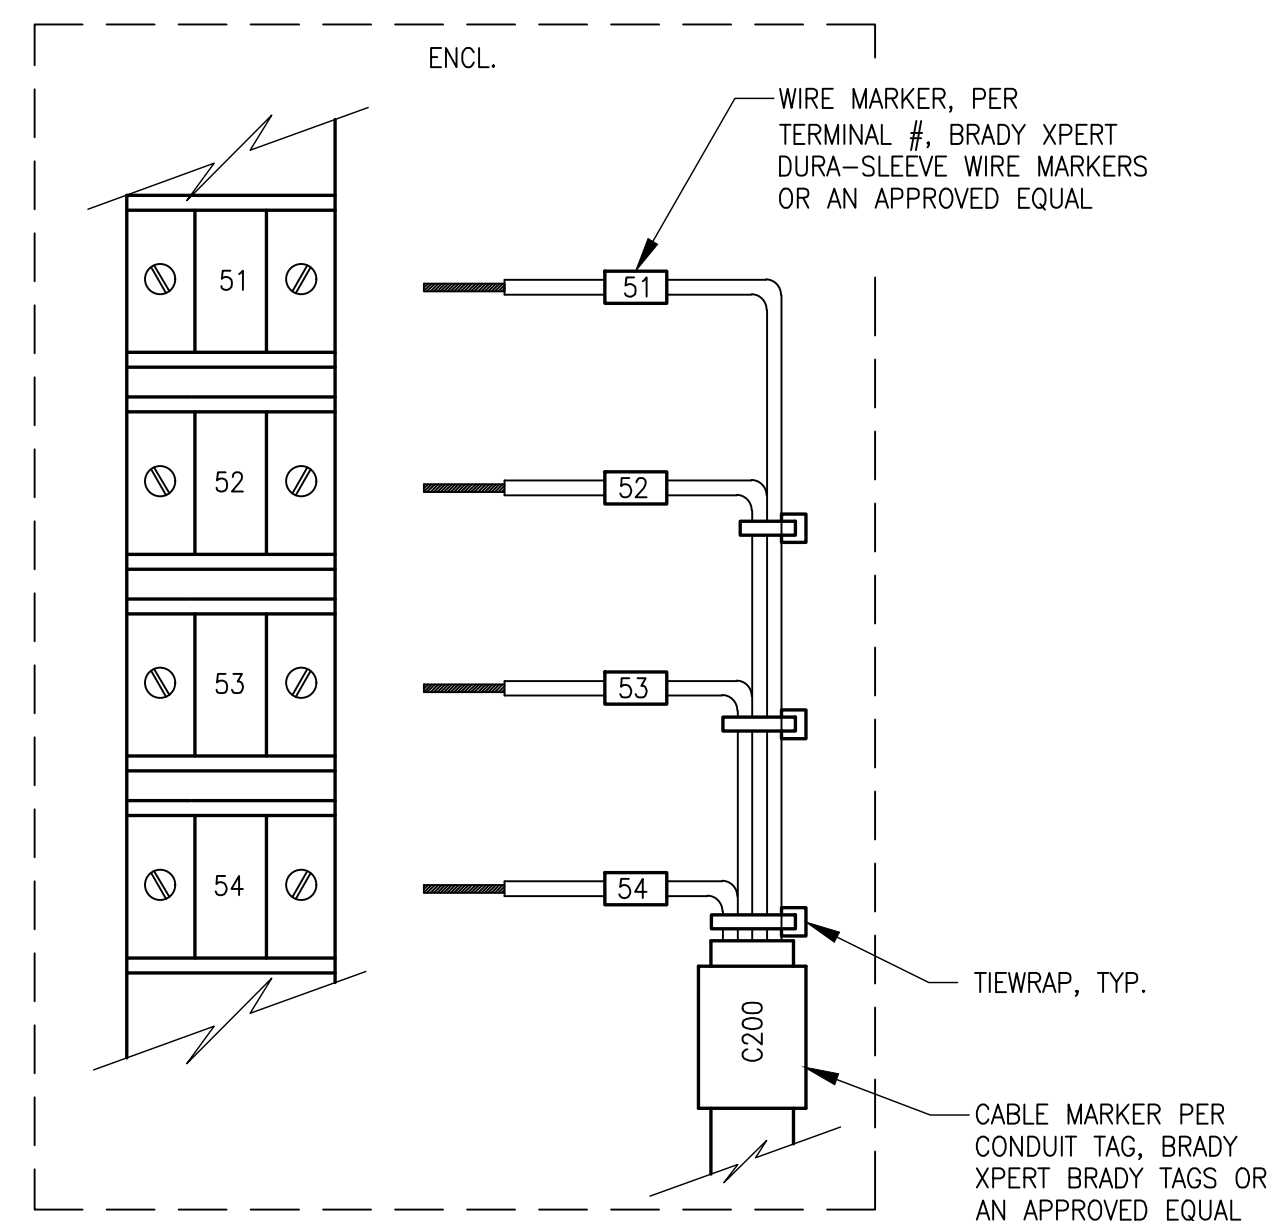
TERMINATION EXAMPLE DETAIL

NTS

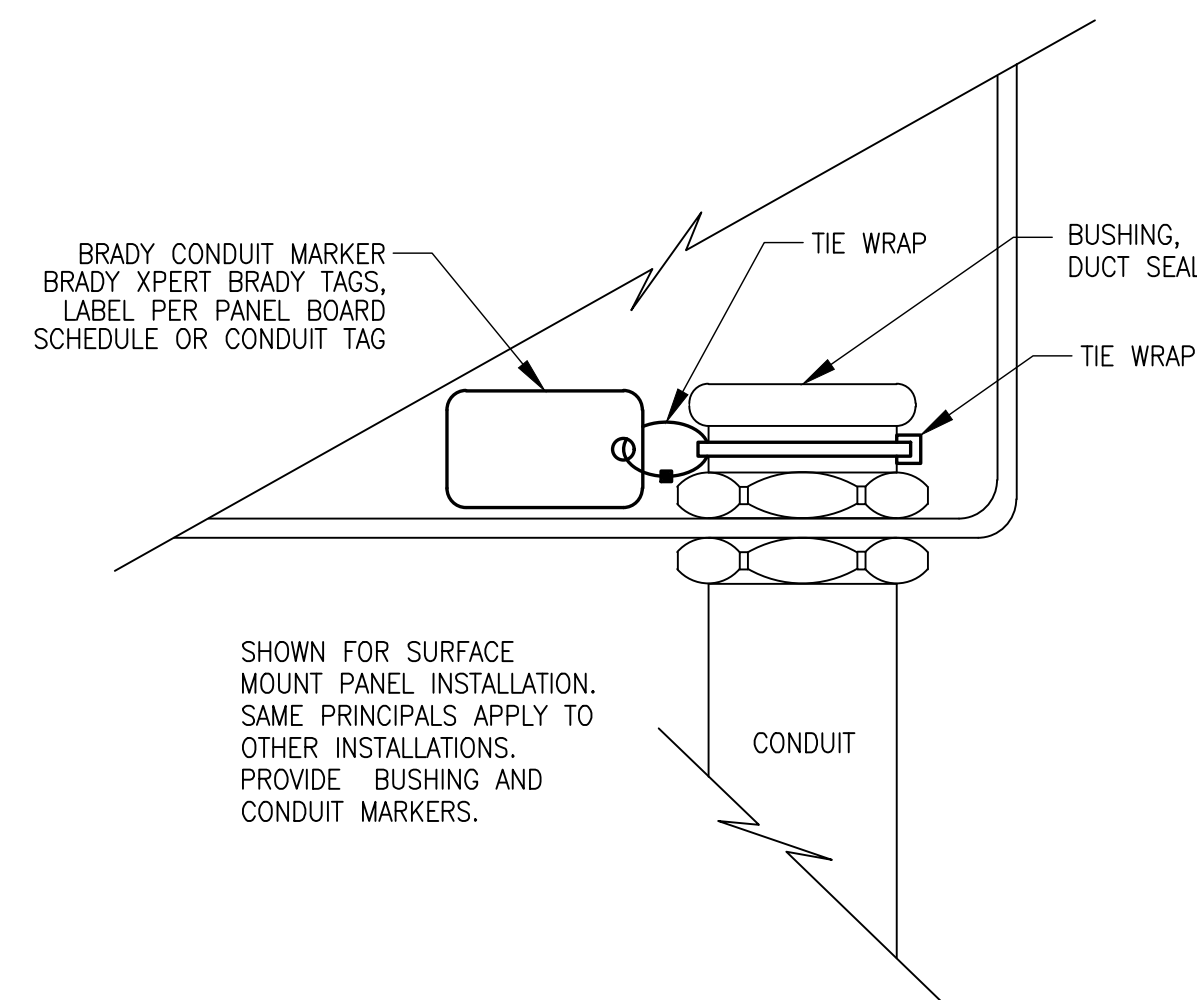


CONDUIT DETAIL

NTS

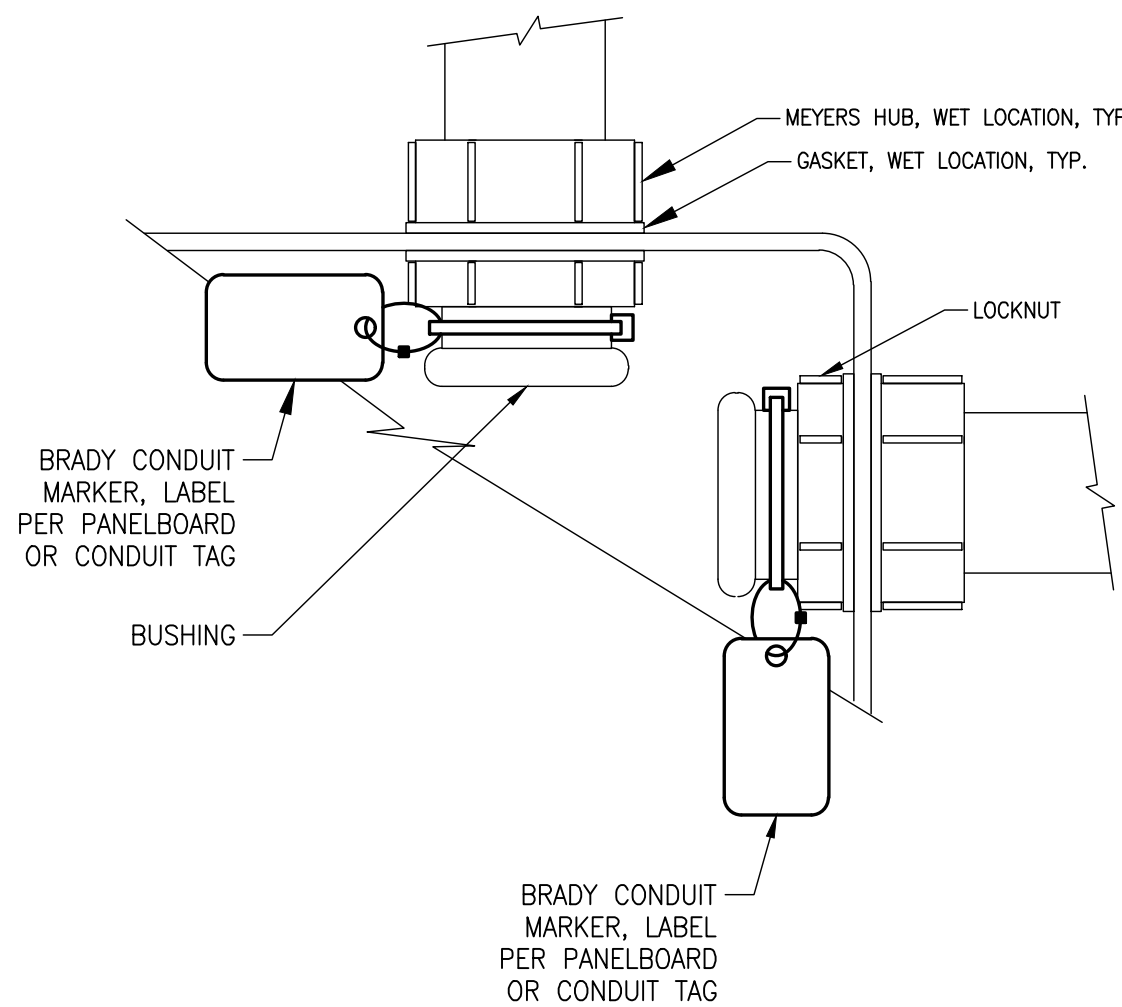


CONDUIT TERMINATION DETAIL

NTS

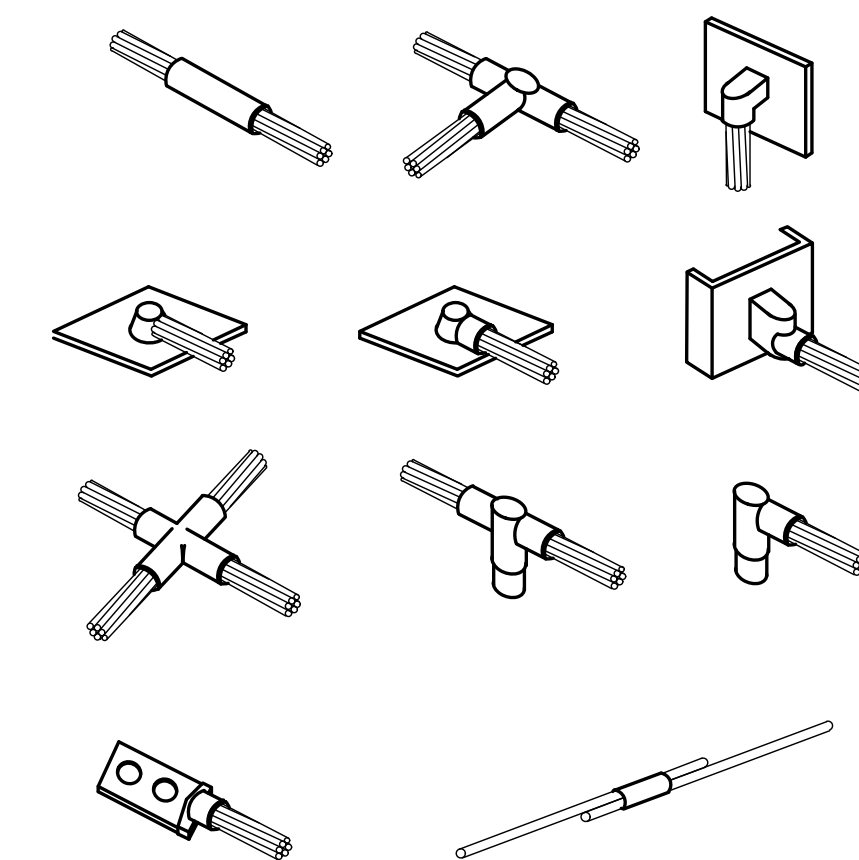

CADWELD DETAILS

NTS

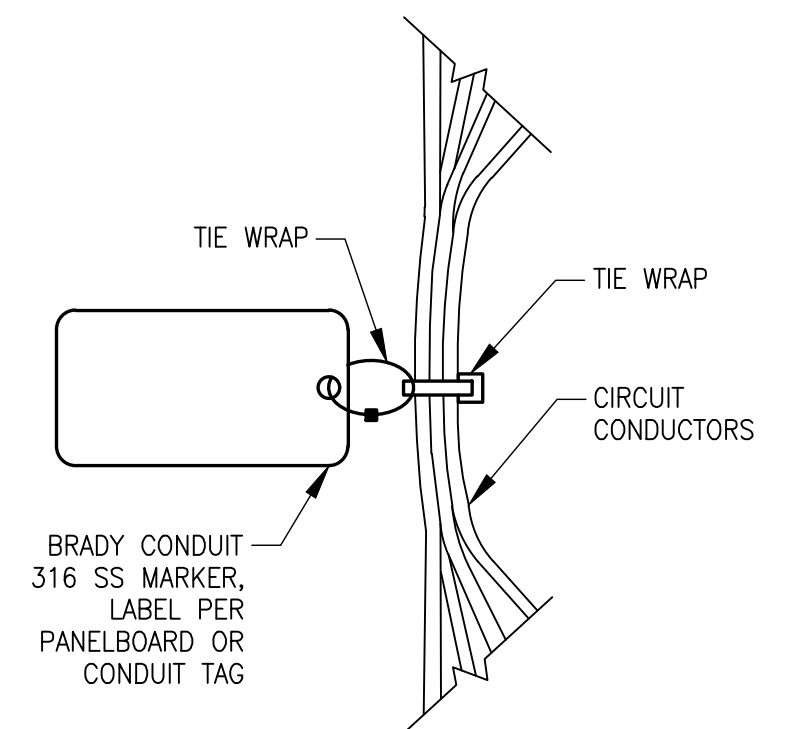

CIRCUIT MARKER DETAIL

NTS

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